REMODEL FOR:

PERMIACARE



400 N. CARVER STREET, BUILDING B RFP 24-0607

LIST OF DRAWINGS

A01 COVER SHEET

REGULATORY, CODE AND ZONING

ZC01 OCCUPANCY CODE ANALYSISTAS1 TAS INFORMATIONTAS2 TAS INFORMATION

ARCHITECTURAL

C101 EXISTING IMPROVEMENTS SURVEY

D101 DEMO PLAN ASP101 SITE PLAN

A201 DIMENSIONAL FLOOR PLAN AND PARTITION TYPES

A301 REFLECTED CEILING PLAN

A401 FINISH PLAN
A501 MILLWORK
A601 ELEVATIONS

A801 DOOR SCHEDULE & DETAILS

MECHANICAL

M101 MECHANICAL PLAN


PLUMBING

P101 PLUMBING PLAN

ELECTRICAL

E101 ELECTRICAL PLAN E102 SPECIAL SYSTEMS



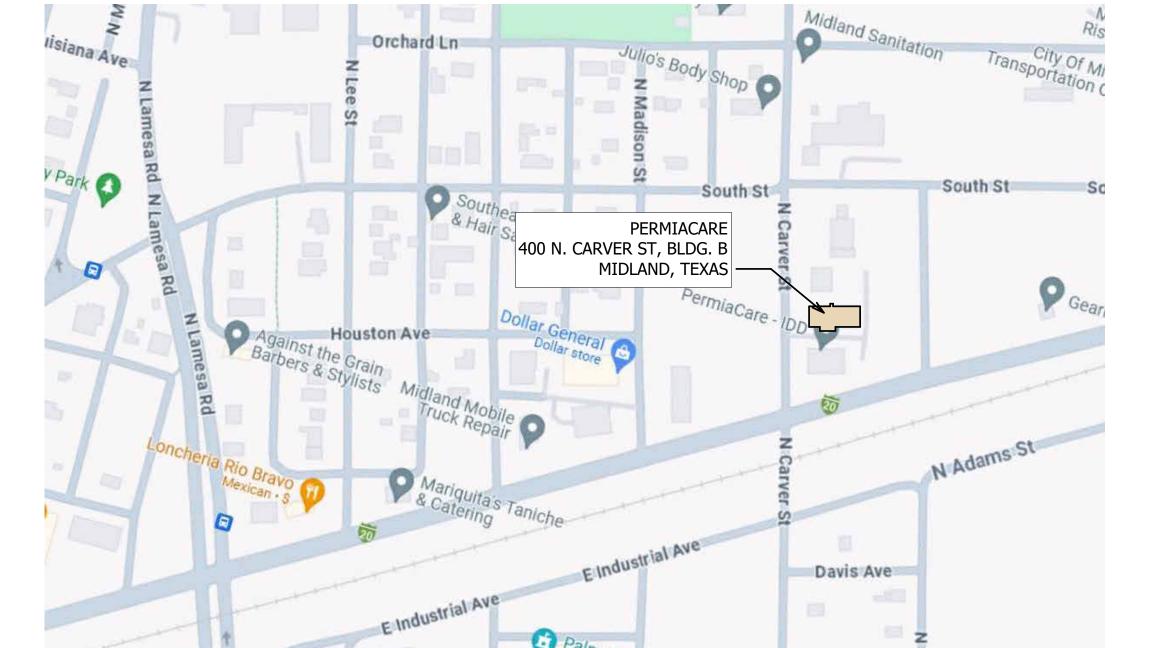

LOCATION MAP

ARCHITECTS:



4500 W. ILLINOIS, SUITE 302 MIDLAND, TEXAS 79703 (432) 697-0037 FAX (432) 697-00 WFP.AIA@PateArchitects.com

TAS: TDLR PROJECT NO: TABS ??????

BID SET NOT FOR PERMITTING,
REGULATORY APPROVAL,
OR CONSTRUCTION
WALTER F. PATE, AIA

MIDLAND, TEXAS 79703 432.697.0037



MIDLAND, TEXAS

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24-0607 REMODEL FOR: PERMIACARE

400 N. CARVER


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A01

NO. 2401





RENOVATION FOR PERMIACARE CODE ANALYSIS

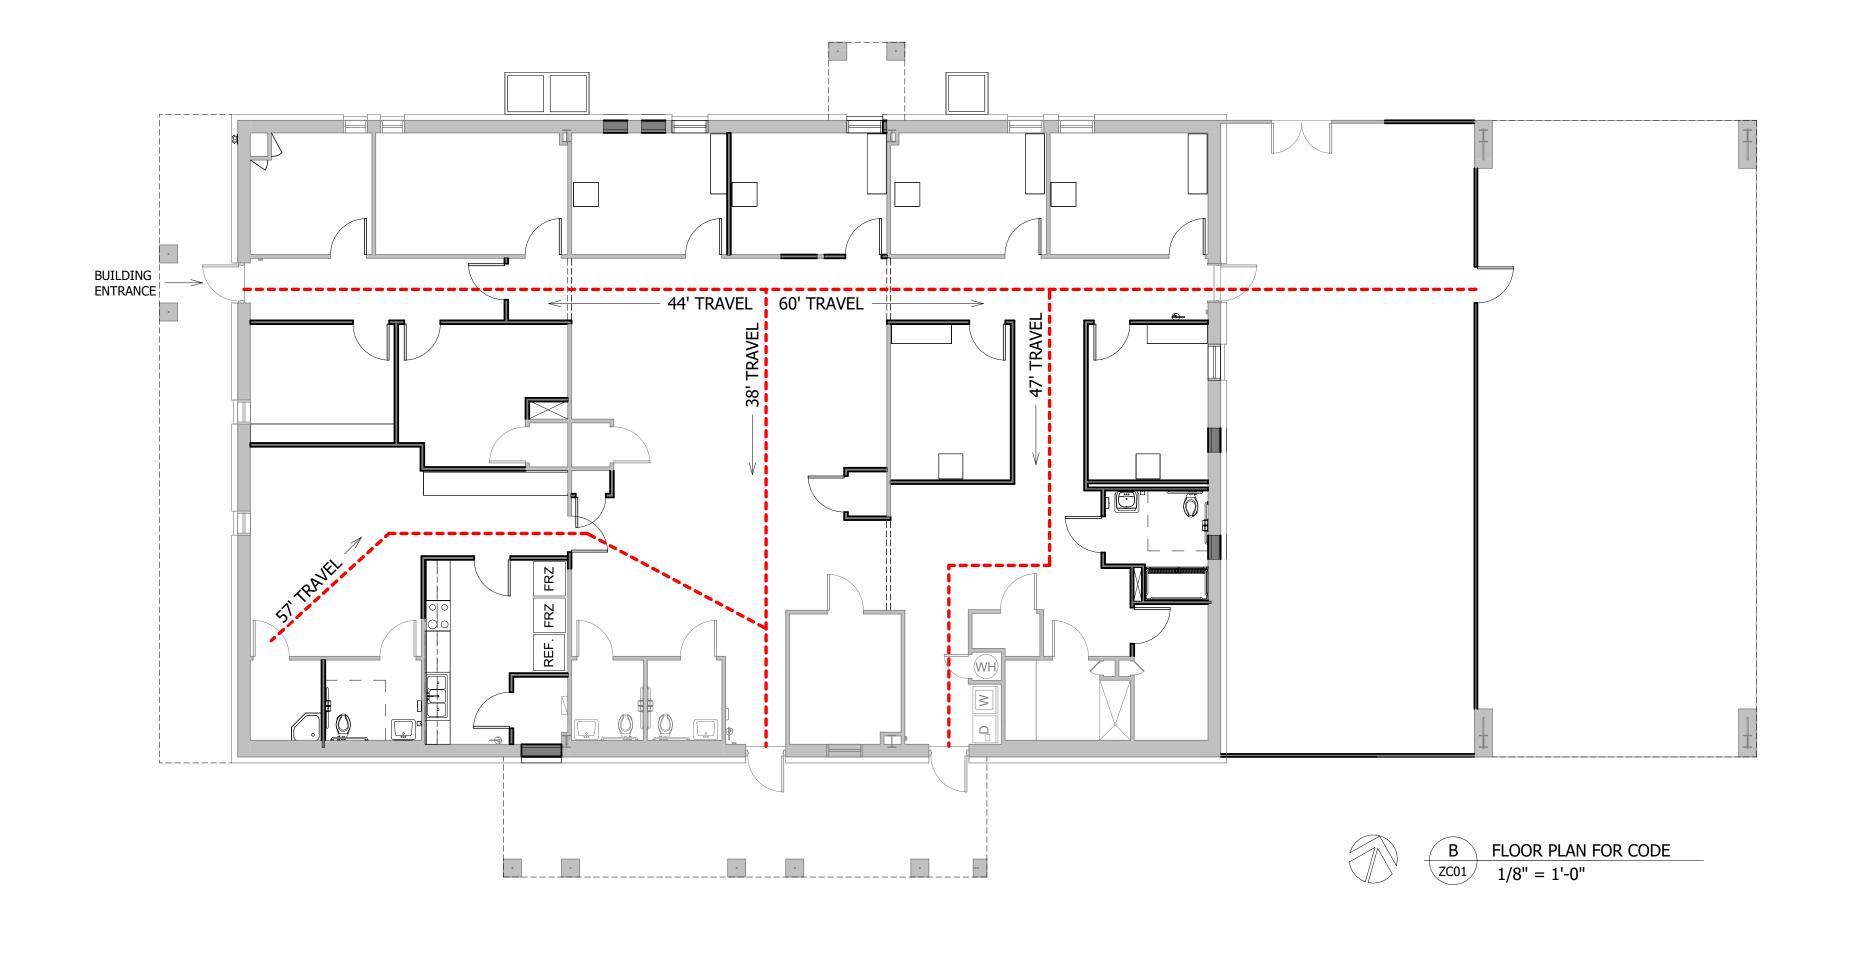APPLICABLE CODES:

2018 IBC - INTERNATIONAL BUILDING CODE 2015 IFC - INTERNATIONAL FIRE CODE 2018 IMC - INTERNATIONAL MECHANICAL CODE 2018 IPC - INTERNATIONAL PLUMBING CODE 2018 IFGC - INTERNATIONAL FUEL GAS CODE

2017 NEC - NATIONAL ELECTRICAL CODE

RESIDENTIAL GROUP R-4

INPATIENT TREATMENT AREAS: SLEEPING AREAS: **RESIDENTIAL AREAS:** 472 SQ. FT. SUPPORT: 546 SQ. FT. CIRCULATION:

TOTAL FLOOR AREA:

TOTAL BUILDING: GROSS: 4,190 SQ. FT. 491 SQ. FT. 1:150 = 4 **BUSINESS AREAS:** 261 SQ. FT. 1:240 = 2 INPATIENT TREATMENT AREAS: SLEEPING AREAS: 657 SQ. FT. 1:120 = 6 **RESIDENTIAL AREAS:** 1,428 SQ. FT. 1:200 = 8

EXISTING FIRE PROTECTION SYSTEM IN PLACE

FIXTURE COUNT REQUIRED PROVIDED

SERVICE SINK:

MINIMUM REQUIRED PLUMBING FIXTURES:

@1:10 LAVATORIES: SHOWERS:

2015 IECC - INTERNATIONAL ENERGY CONSERVATION CODE

2012 TAS - TEXAS ACCESSIBILITY STANDARDS

BUILDING OCCUPANCY

CLASSIFICATIONS: BUSINESS GROUP B

491 SQ. FT. **BUSINESS AREAS** 261 SQ. FT. 657 SQ. FT. 1,428 SQ. FT.

3,855 SQ. FT.

TOTAL OCCUPANCY:

CONSTRUCTION TYPE: II-B (NON-COMBUSTIBLE, NON-PROTECTED)

MINIMUM REQUIRED PLUMBING FIXTURES:

CLASSIFICATIONS: BUSINESS GROUP B

TOTAL OCCUPANCY:

WATER CLOSETS: @1:25 LAVATORIES: @1:40

CLASSIFICATIONS: RESIDENTIAL GROUP R-4

TOTAL OCCUPANCY: 16 REQUIRED PROVIDED FIXTURE COUNT WATER CLOSETS: @1:10

1

SERVICE SINK:

FOR: PERMIACARE

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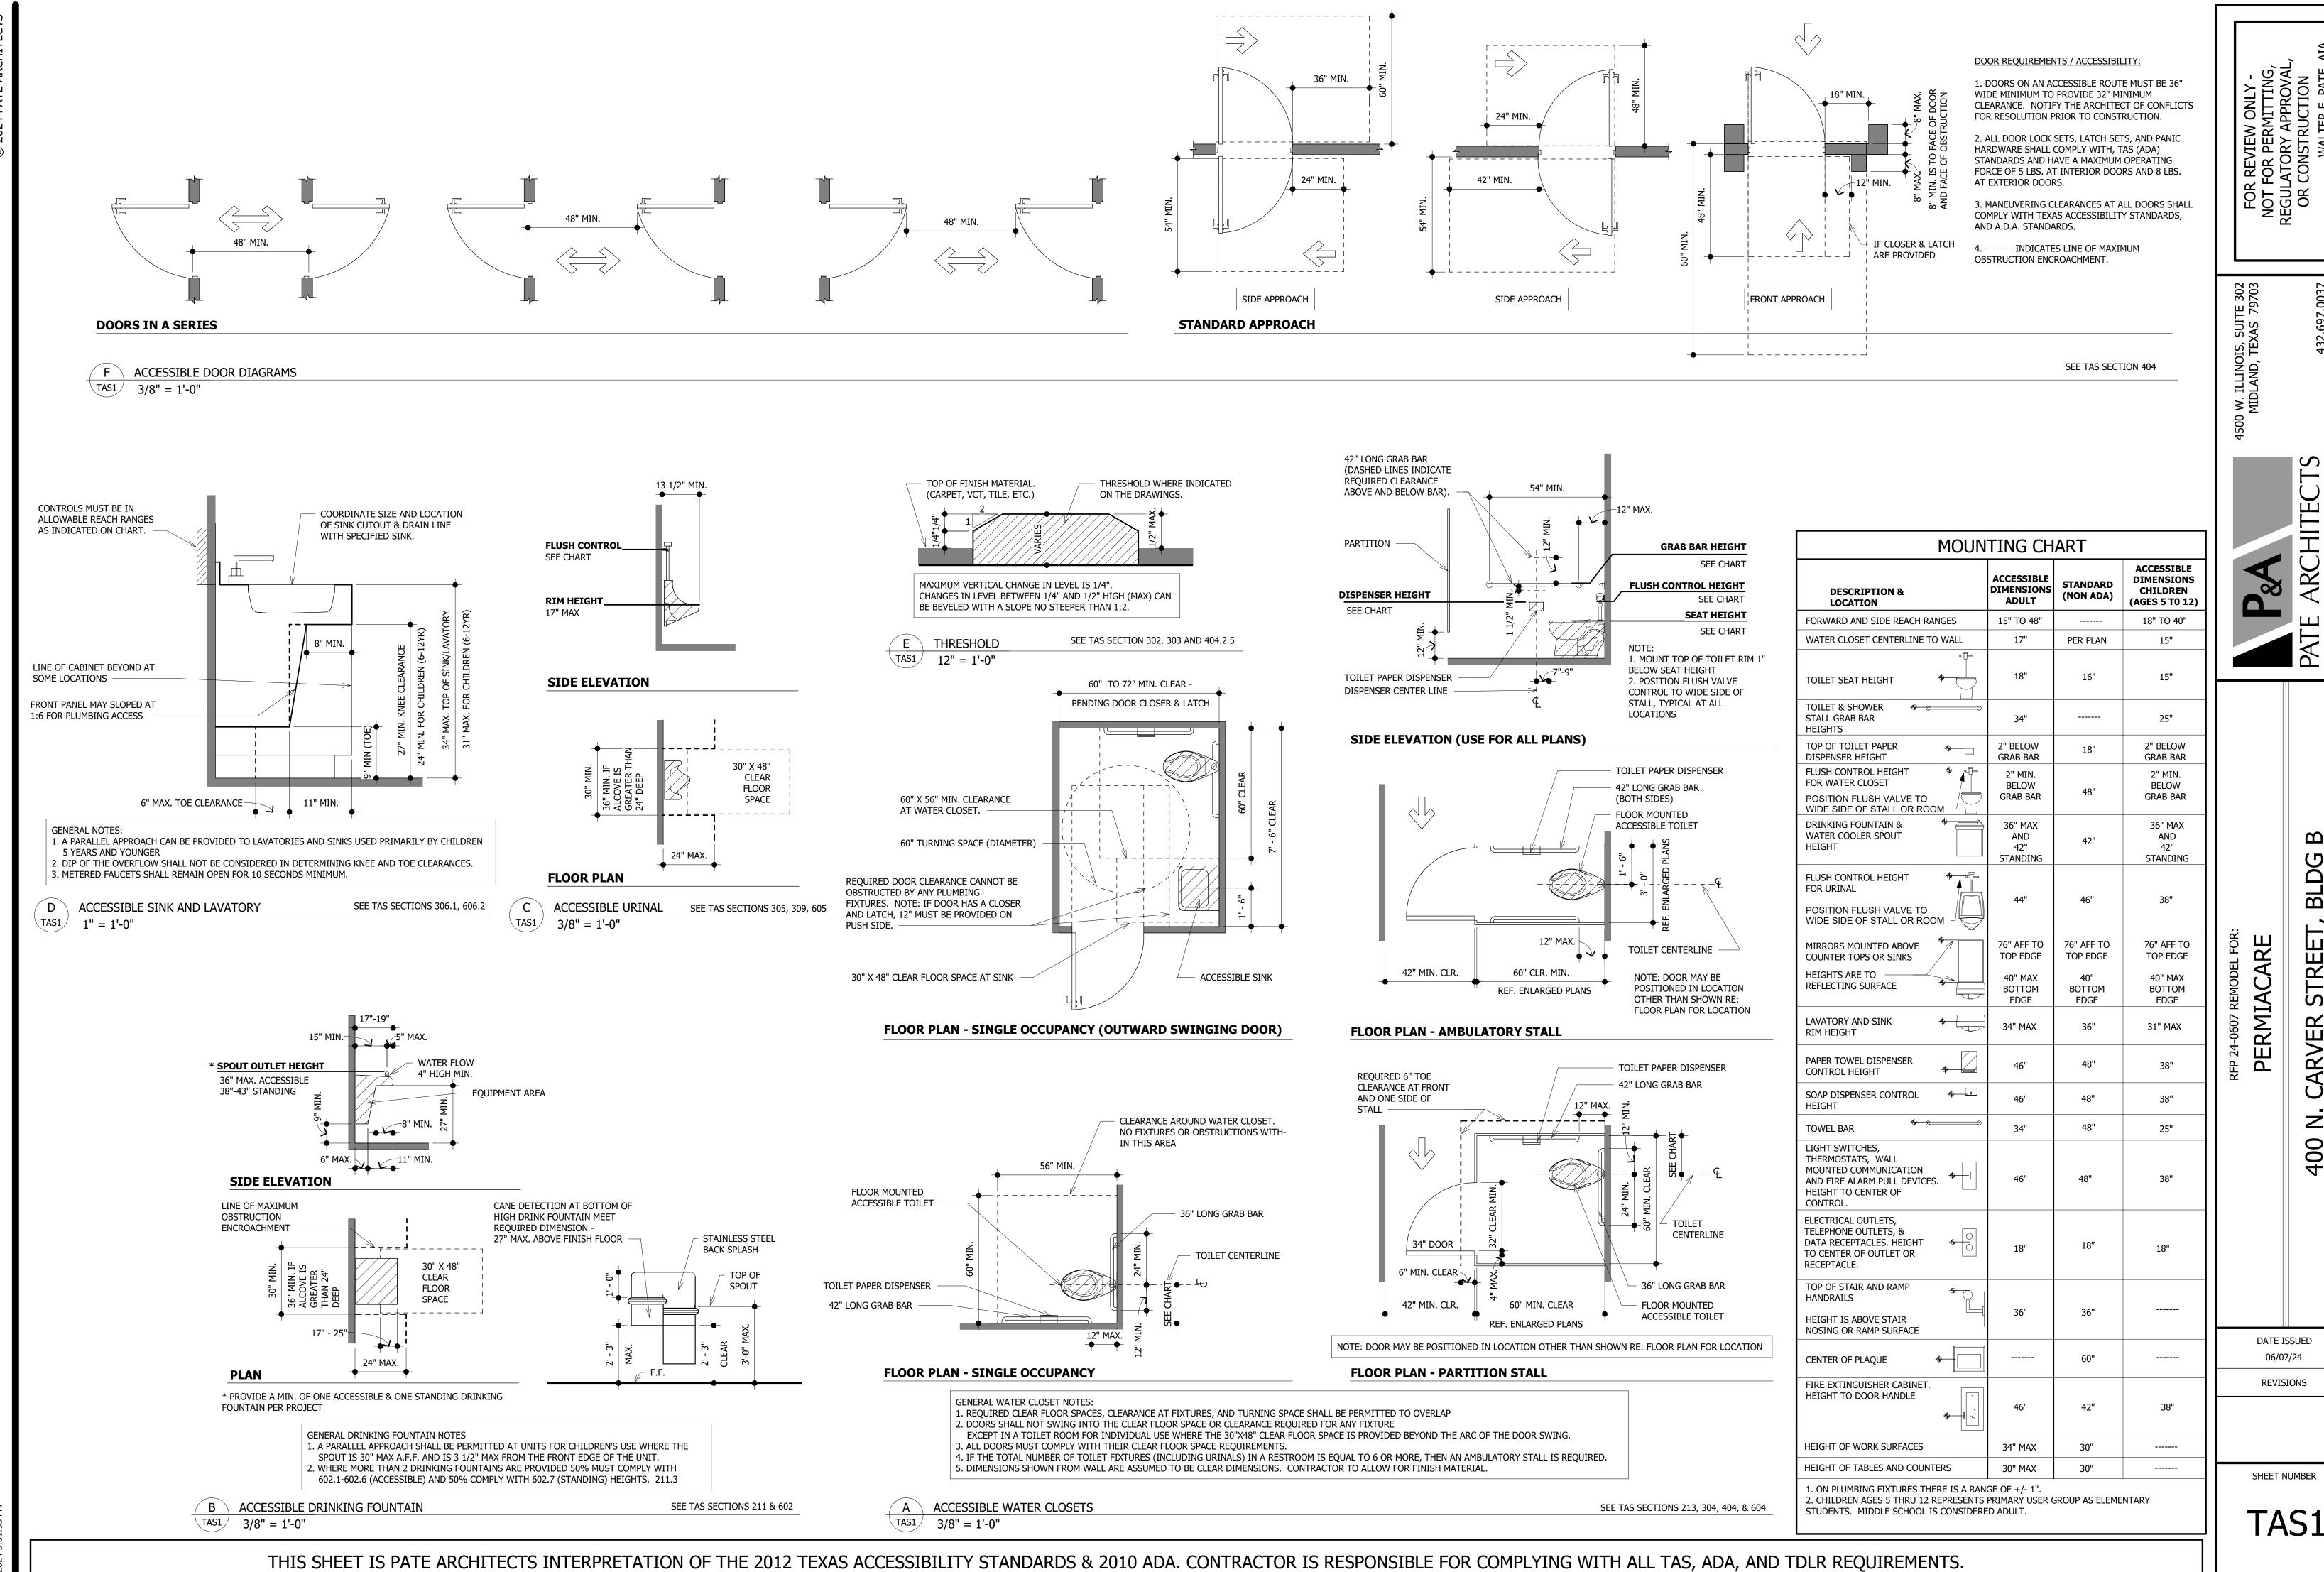
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2401A JOB NO.

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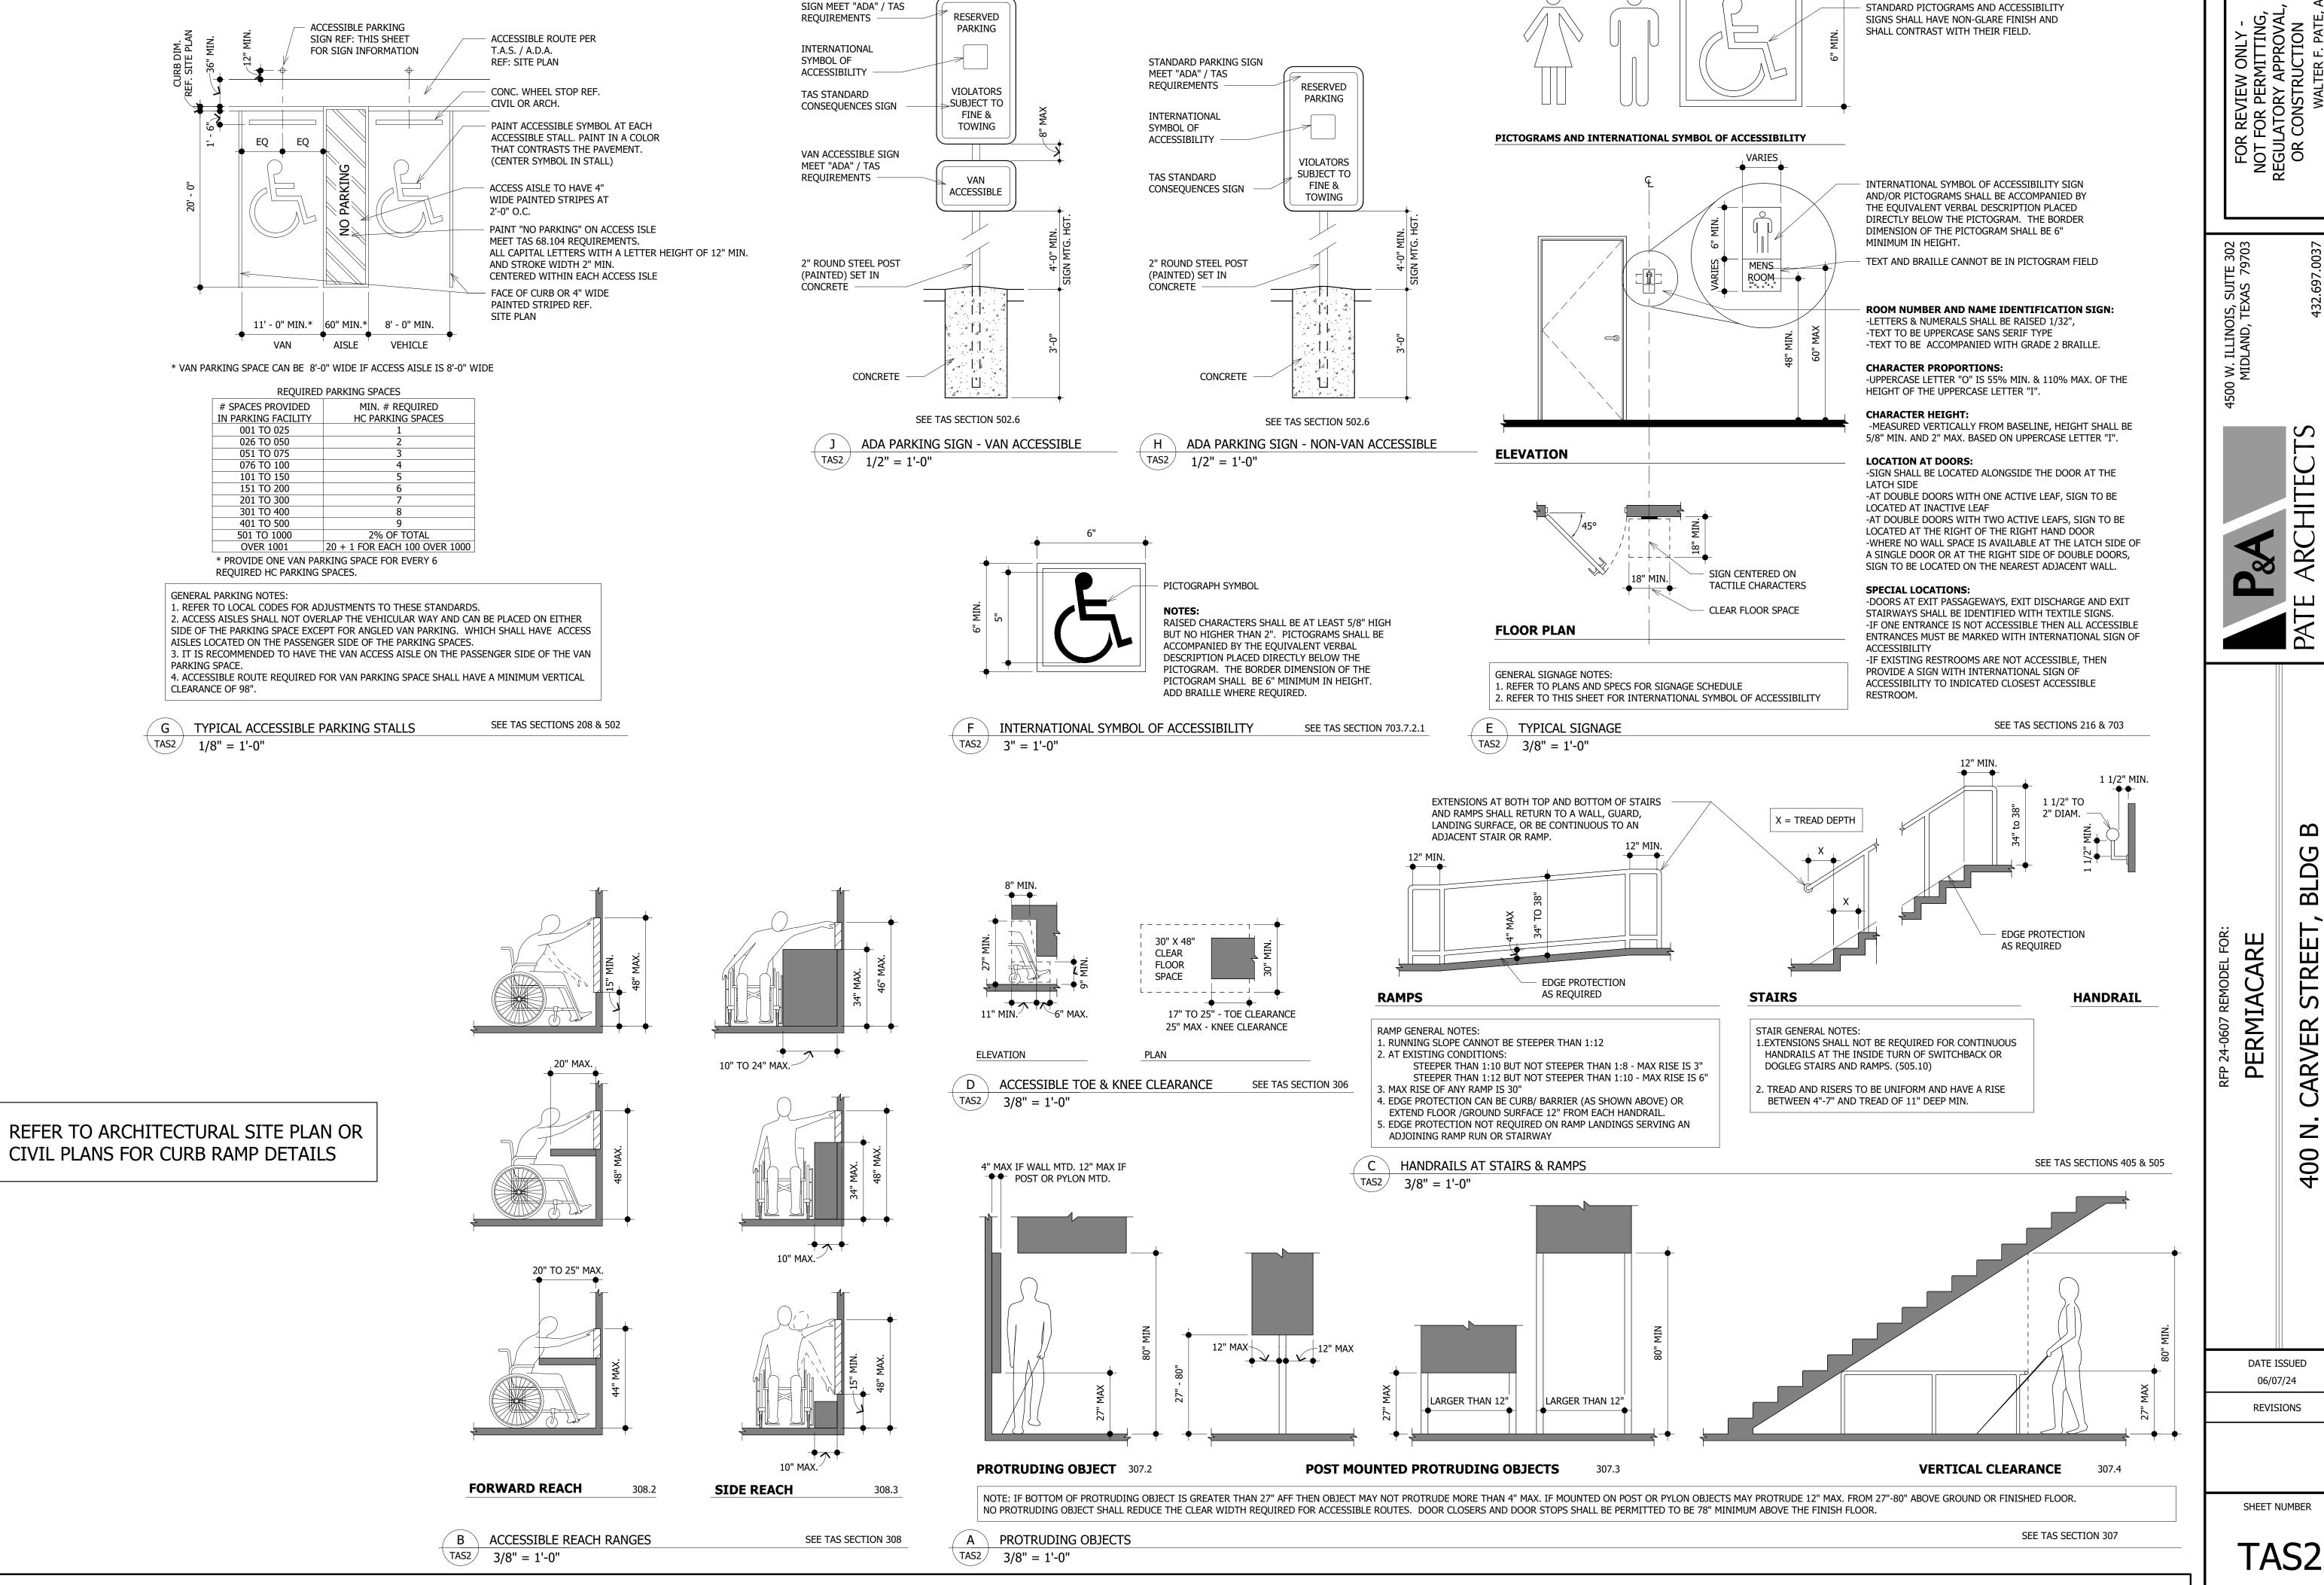


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VERIFY CONFLICTS OR DISCREPANCIES BETWEEN STANDARDS AND DRAWINGS WITH PATE ARCHITECTS. NOT ALL STANDARDS ARE COVERED ON THESE SHEETS.




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STANDARD PARKING



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24-0607 REMODEL F PERMIACARE

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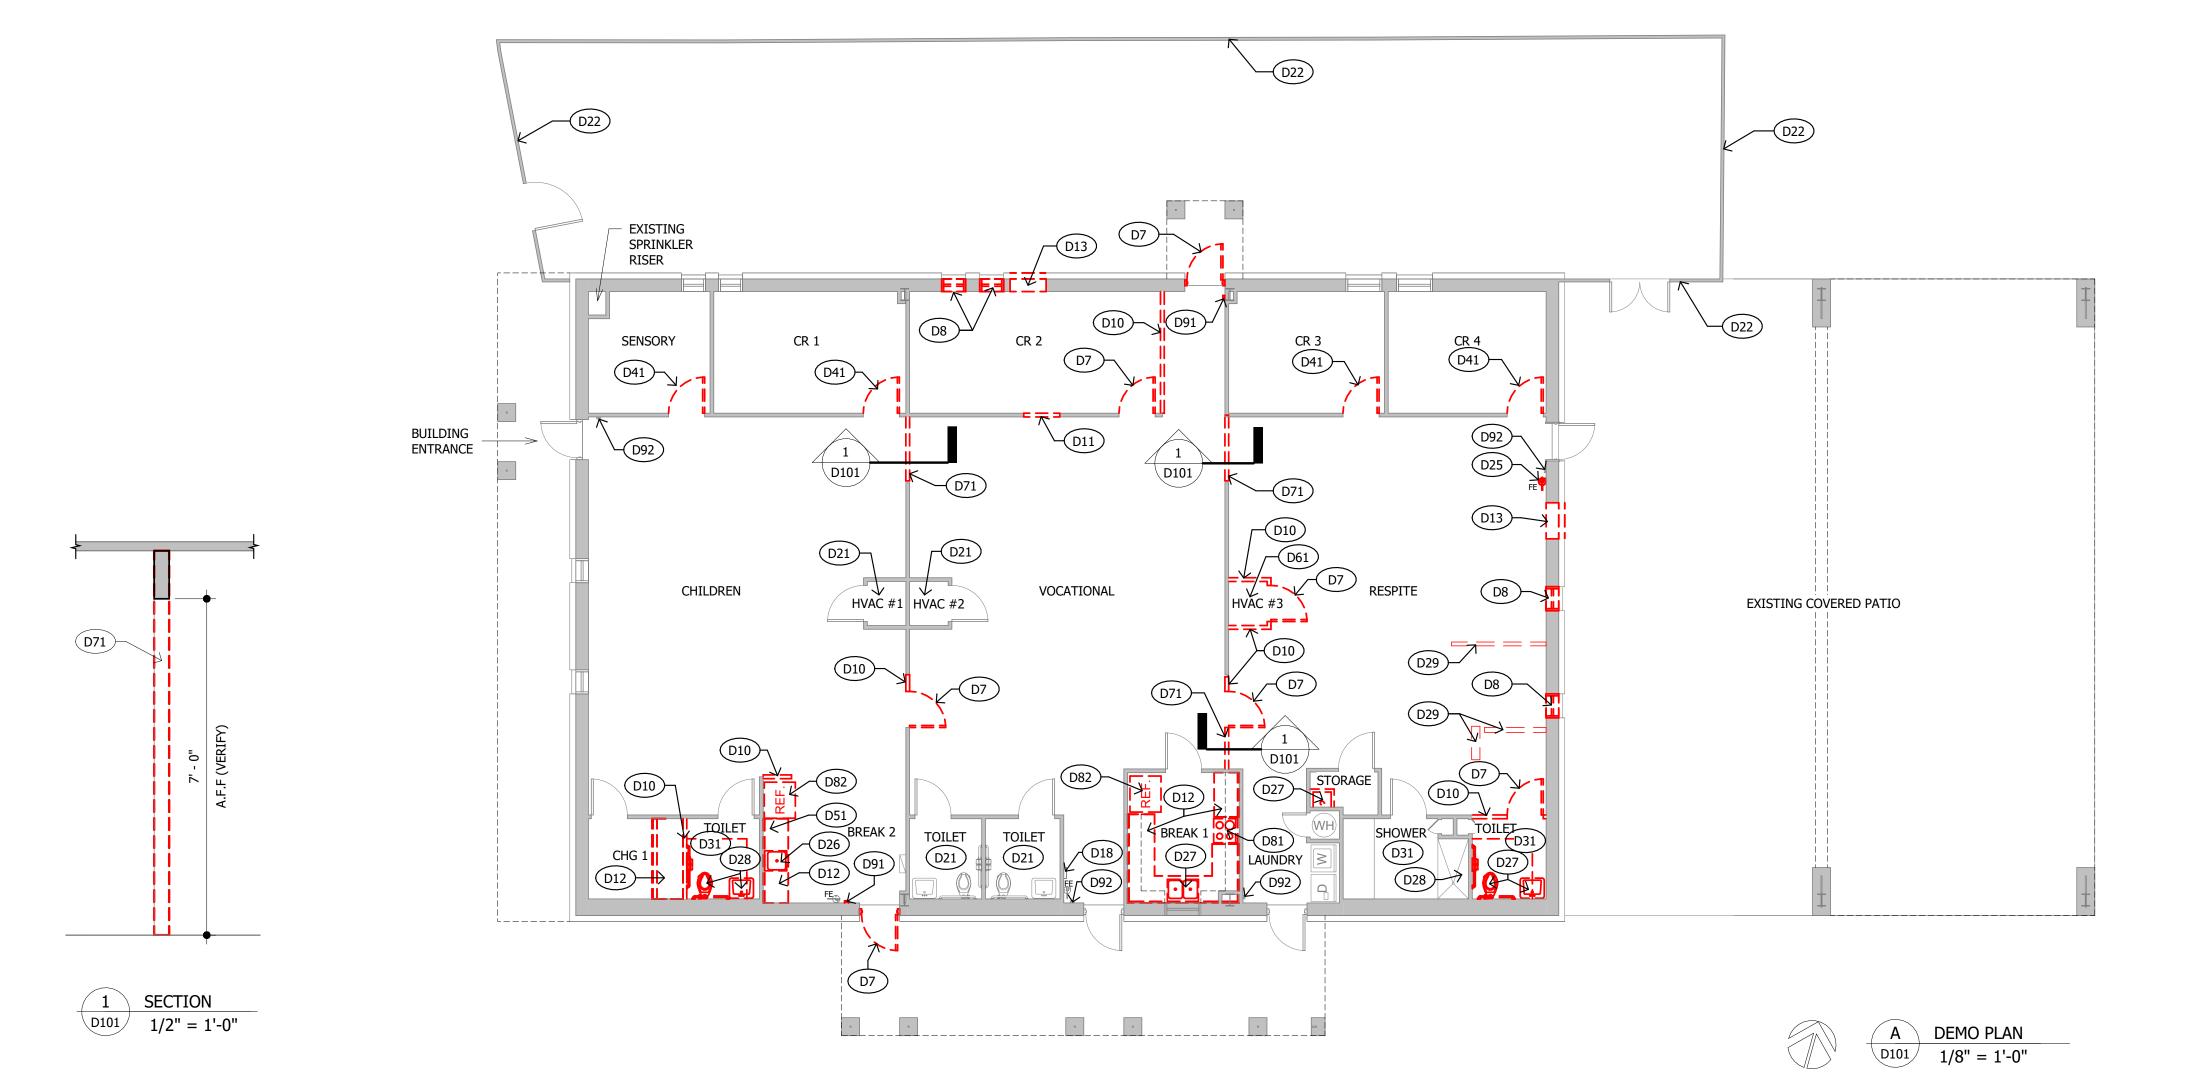
REVISIONS

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- G1 ALL CONSTRUCTION TO COMPLY WITH LOCAL BUILDING CODES AND ORDINANCES AND REQUIREMENTS OF THE TEXAS ACCESSIBILITY STANDARDS (TAS).
- INFORMATION SHOWN REGARDING THE EXISTING BUILDING IS CORRECT TO THE BEST KNOWLEDGE AND BELIEF OF THE ARCHITECT. MINOR DISCREPANCIES MAY BE FOUND. THE GENERAL CONTRACTOR IS RESPONSIBLE FOR REVIEWING AND FIELD VERIFYING ALL CONDITIONS AT THE JOB SITE.
- G3 THE OWNERS ADJACENT BUILDING WILL REMAIN OPEN AND OPERATIONAL DURING NORMAL BUSINESS HOURS THROUGHOUT THE CONSTRUCTION PERIOD.
- G7 PROTECT EXISTING CONSTRUCTION WHICH IS TO REMAIN (I.E., WALLS, CEILINGS, DOORS, FINISHES, ETC.) FROM DAMAGE DURING DEMOLITION AND CONSTRUCTION. REPAIR OR REPLACE DAMAGED MATERIALS OR SURFACES WHICH ARE INDICATED TO REMAIN; MATCH EXISTING.
- G8 PURCHASE BUILDING PERMITS PRIOR TO ANY CONSTRUCTION OR DEMOLITION WORK. SUPPLY A PHOTOCOPY OF ALL PERMITS TO THE OWNER PRIOR TO BEGINNING WORK WITHIN THE BUILDING.
- G9 CONSTRUCTION PERSONNEL ARE TO PARK IN REMOTE AREAS. DO NOT USE THE CLOSE-IN PARKING INTENDED FOR OCCUPANTS AND VISITORS OF OTHER BUILDINGS.
- G10 PROVIDE AND PAY FOR SEPARATE TRASH COLLECTION. DO NOT USE THE BUILDING DUMPSTERS.
- G18 PROVIDE AND PAY COST OF SITE OFFICE (WITH PHONE AND PHONE ANSWERING MACHINE) AND JOB TOILETS.
- G19 LOCATE JOB OFFICE, PARKING AND STORED MATERIALS IN THE CONSTRUCTION STAGING AREA AS SHOWN ON THE DRAWINGS.

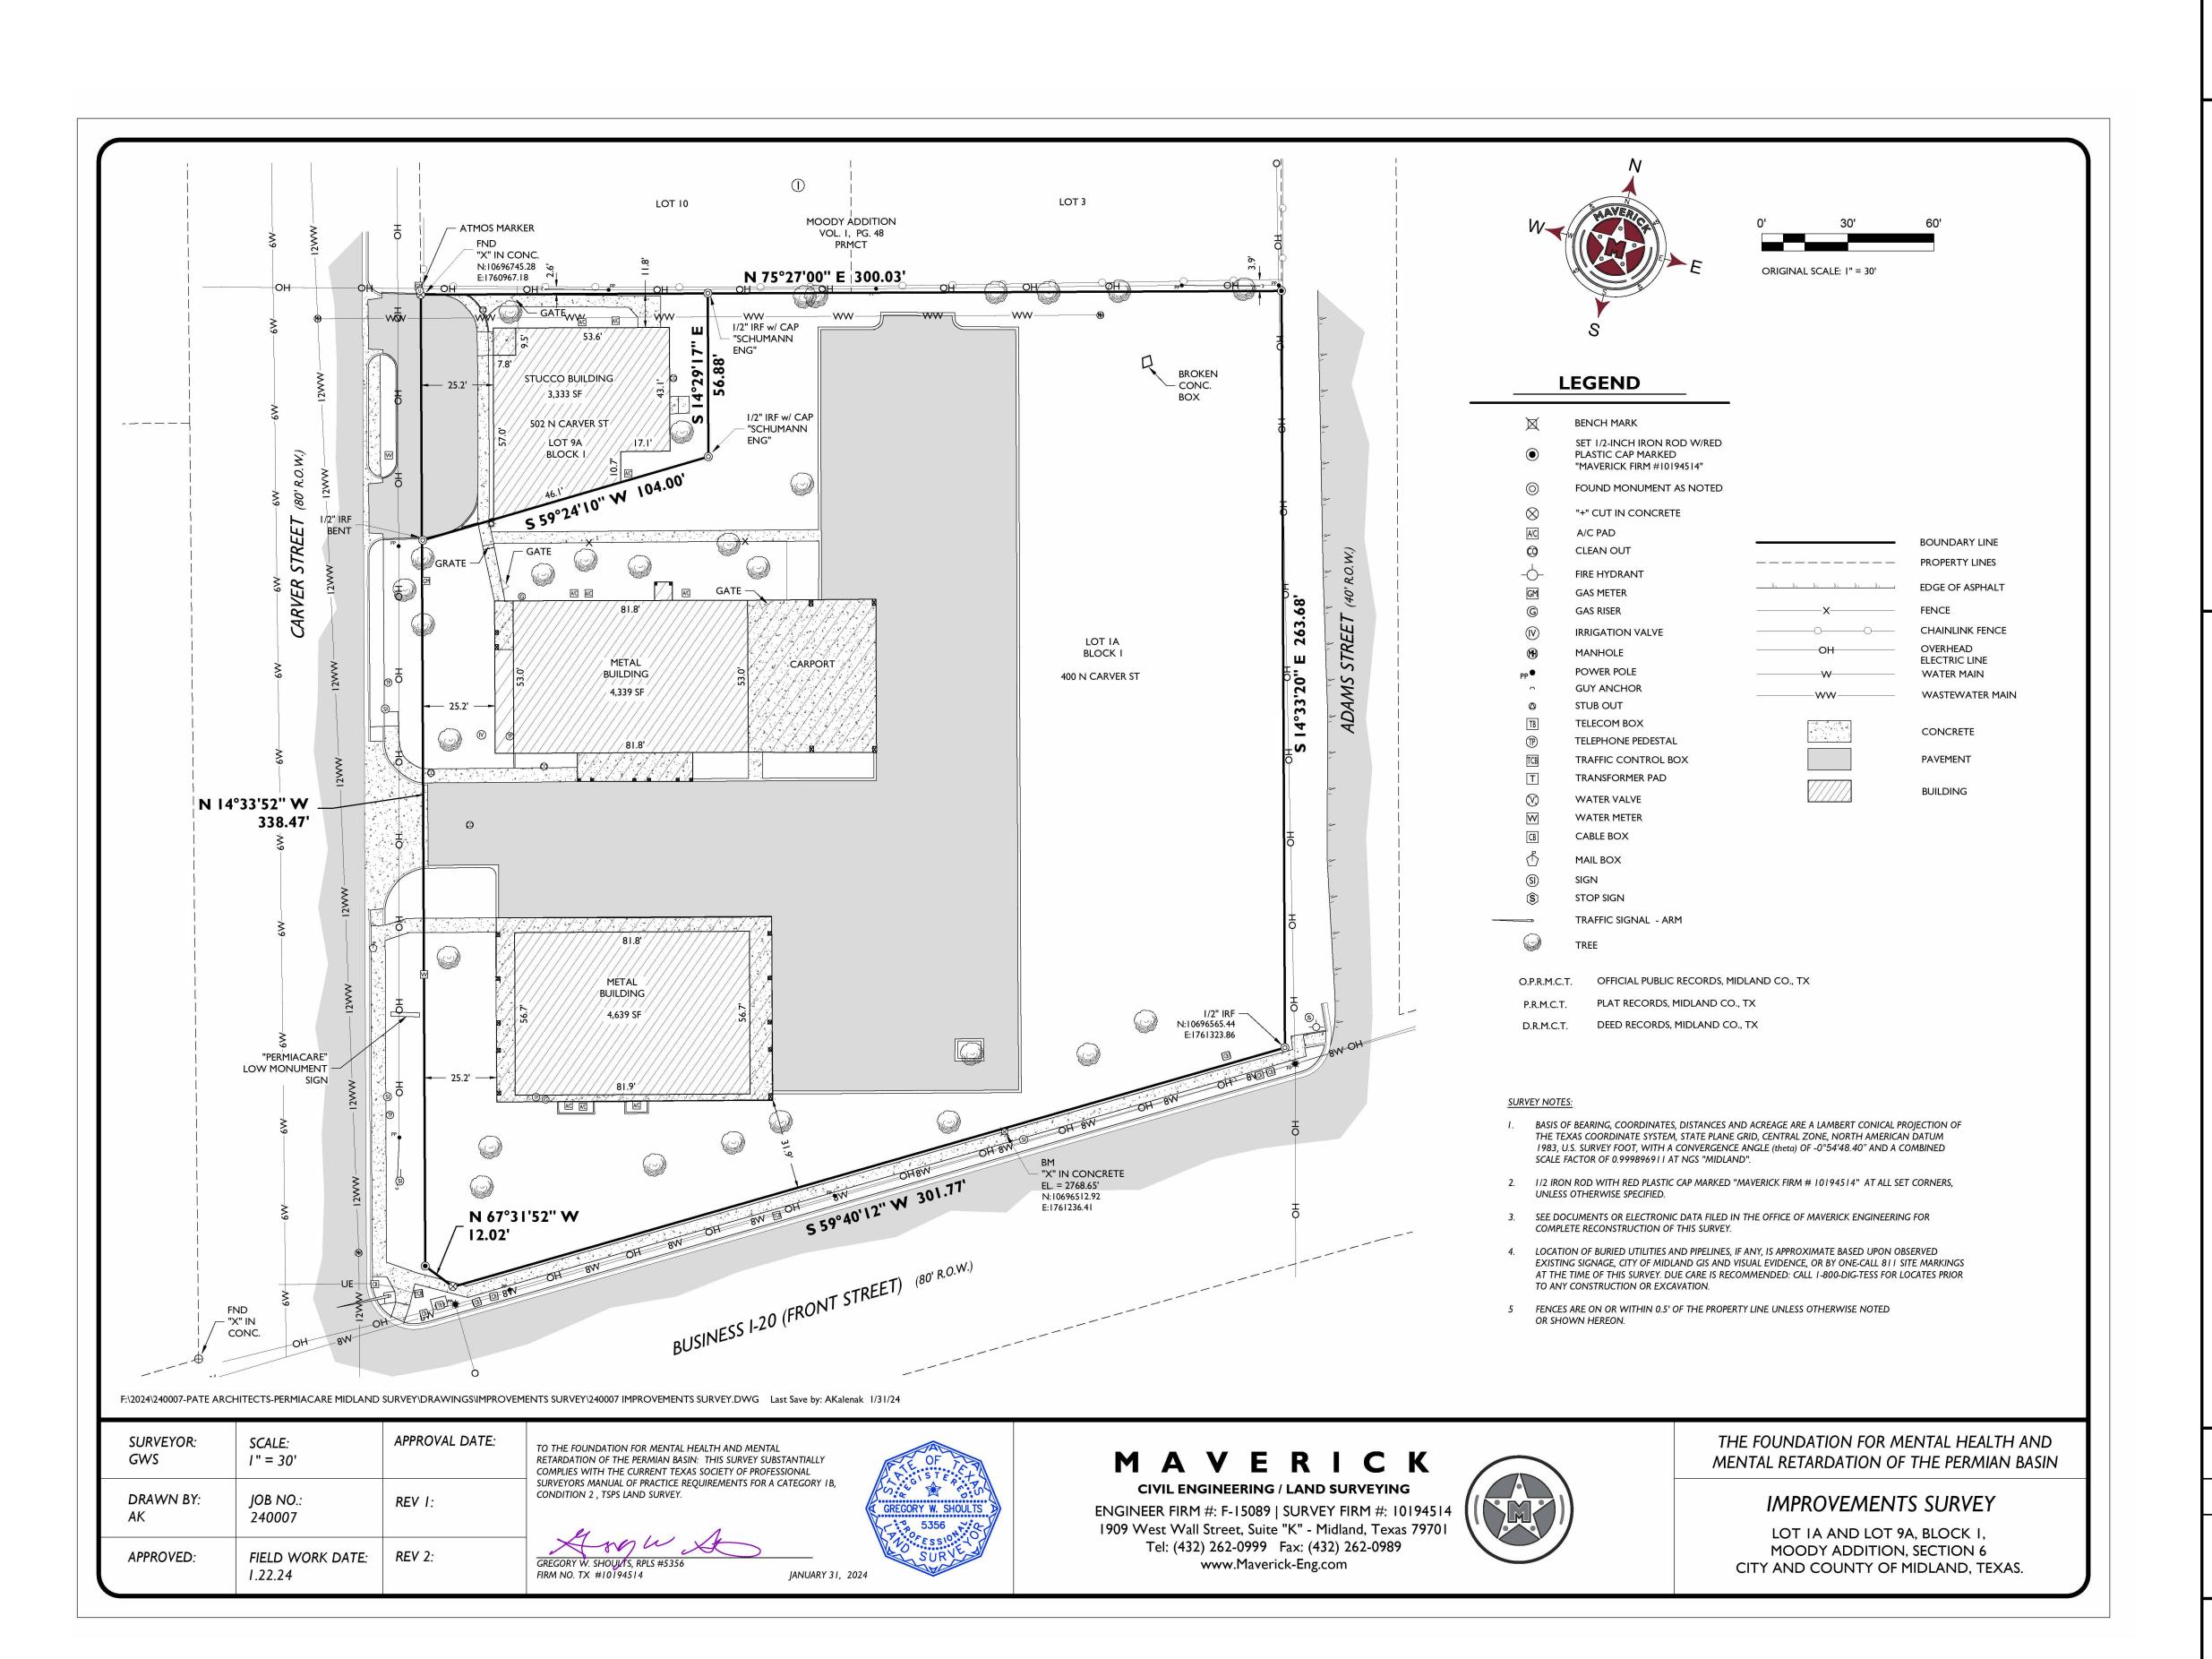DEMO KEYNOTES

- BEFORE BEGINNING ANY DEMOLITION OR NEW CONSTRUCTION WORK, REVIEW THE DRAWINGS AND CONSULT WITH THE BUILDING OWNER FOR PROCEDURE AND REQUIREMENTS TO BE FOLLOWED FOR THE DURATION OF THE PROJECT.
- PROTECT EXISTING CONSTRUCTION WHICH IS TO REMAIN (I.E., WALLS, CEILING, DOORS, FINISHES, MILLWORK, ETC.) FROM DAMAGE DURING DEMOLITION AND CONSTRUCTION. REPAIR OR REPLACE DAMAGED MATERIALS OR SURFACES WHICH ARE INDICATED TO REMAIN: MATCH EXISTING.
- CAREFULLY REMOVE, PROTECT FROM DAMAGE AND SALVAGE FOR REUSE (AS SPECIFICALLY INDICATED ON THE DRAWINGS OR AS REQUIRED) EXISTING FLUORESCENT AND INCANDESCENT LIGHT FIXTURES, EXISTING ELECTRICAL DEVICES AND DEVICE PLATES, DOORS AND FRAMES, DOOR HARDWARE, ETC. REUSE AS MUCH OF SALVAGED MATERIALS AS IS PRACTICAL. RETURN UN-REUSED MATERIALS TO OWNER'S STOCKPILE.
- HEAVY RED DASHED LINES INDICATE EXISTING CONSTRUCTION TO BE REMOVED OR DEMOLISHED. SAW CUT JOINTS AS REQUIRED.
- LIGHT (HALF TONE) LINES INDICATED EXISTING CONSTRUCTION TO REMAIN "AS IS" (INTACT)
- COMPLETELY REMOVE DEMOLISHED MATERIALS. DO NOT LEAVE ABANDONED DUCTS CONDUITS, PIPE, WIRE, ETC. IN PLACE.
- REMOVE DOOR AND FRAME. SALVAGE, PROTECT AND REUSE DOORS AND FRAMES. REPAIR ANY DOOR SCRATCHES OR DAMAGE.
- REMOVE WINDOW. SALVAGE FOR REUSE. REUSE WINDOWS WHERE POSSIBLE.
- REMOVE EXISTING WALL CONSTRUCTION AND ELECTRICAL WORK. RELOCATE OR REWIRE (AS REQUIRED) LIGHT SWITCHES IN WALLS WHICH ARE DEMOLISHED.
- DEMO WALL AS REQUIRED FOR NEW DOOR LOCATION
- D12 DEMO EXISTING MILLWORK AS REQUIRED FOR NEW CONSTRUCTION.
- D13 DEMO WALL AS REQUIRED FOR NEW WINDOW LOCATION.
- D18 PROTECT EXISTING FIRE ALARM PANEL FROM DAMAGE DURING CONSTRUCTION.
- D19 PROTECT EXISTING FIRE PROTECTION SPRINKLER SYSTEM. (TYPICAL)
- D21 NO DEMOLITION WORK IN THIS AREA.
- D22 PROTECT EXISTING FENCE FROM DAMAGE DURING CONSTRUCTION.
- RELOCATE EXISTING FIRE EXTINGUISHER.
- DEMO PLUMBING FIXTURE ONLY. KEEP WASTELINE FOR REUSE. COORDINATE WITH PLUMBING PLAN.
- D27 DEMO AND SALVAGE PLUMBING FIXTURES. DEMO WASTE LINES IN FLOOR. CAP EXISTING ABANDONED SEWER LINES BELOW FLOOR. FILL HOLES IN FLOOR WITH CONCRETE.
- D28 DEMO EXISTING PLUMBING FIXTURES, GRAB BARS AND TOILET ACCESSORIES AND PREPARE FOR NEW.
- D29 DEMO AND REMOVE EXISTING CONCRETE AS REQUIRED FOR NEW PLUMBING AND SHOWER. VERIFY EXACT LOCATION.
- D31 DEMO EXISTING WALL TILE AND PREPARE WALLS FOR NEW TILE.
- D41 REMOVE DOOR ONLY. SALVAGE, PROTECT AND REUSE DOORS WHERE POSSIBLE. REPAIR ANY DOOR SCRATCHES OR DAMAGE.
- D51 DEMO EXISTING NETWORK HUB AND RELOCATE.
- DEMO EXISTING HVAC UNIT AND RELOCATE.
- DEMO LOWER PORTION OF WALL AND LEAVE FURR DOWN. SEE SECTION 1/D101.
- SALVAGE STOVE FOR REUSE.
- D82 SALVAGE REFRIGERATOR FOR REUSE.
- DEMO EXISTING FIRE ALARM PULL STATION AND RELOCATE.
- D92 PROTECT EXISTING FIRE ALARM PULL STATION FROM DAMAGE DURING CONSTRUCTION.



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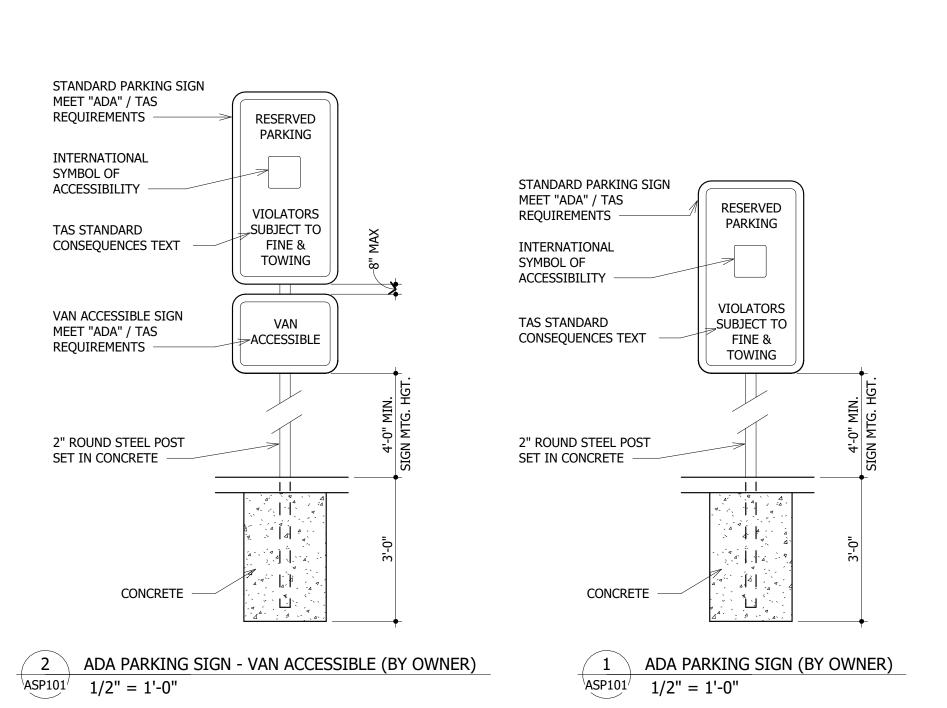
D101


GENERAL KEYNOTES


- ALL CONSTRUCTION TO COMPLY WITH LOCAL BUILDING CODES AND ORDINANCES AND REQUIREMENTS OF THE TEXAS ACCESSIBILITY STANDARDS (TAS).
- INFORMATION SHOWN REGARDING THE EXISTING BUILDING IS CORRECT TO THE BEST KNOWLEDGE AND BELIEF OF THE ARCHITECT. MINOR DISCREPANCIES MAY BE FOUND. THE GENERAL CONTRACTOR IS RESPONSIBLE FOR REVIEWING AND FIELD VERIFYING ALL CONDITIONS AT THE JOB SITE.
- LOCATE JOB OFFICE, PARKING AND STORED MATERIALS IN THE CONSTRUCTION STAGING AREA AS SHOWN ON THE DRAWINGS.


SITE KEYNOTES


- SP05 PAINT INTERNATIONAL SYMBOL OF ACCESS IN PARKING SPACE COMPLY WITH TAS STANDARDS. (BY OWNER)
- IDENTIFY ACCESSIBLE ACCESS AISLE WITH 4" WIDE PAINTED STRIPES (DIAGONAL) AT 24" O.C. PAINT TEXT "NO PARKING" IN ACCESS AISLE. COMPLY WITH TAS STANDARDS. SEE DETAIL B/ASP101. (BY OWNER)
- SP10 ACCESSIBLE PARKING SIGN SEE DETAIL 1/ASP101 (BY OWNER)
- ACCESSIBLE PARKING SIGN VAN ACCESSIBLE SEE DETAIL 2/ASP101 (BY OWNER)
- PROTECT EXISTING MECHANICAL CONDENSING UNITS AND CONCRETE PAD.
- EXISTING GAS METER. PROTECT FROM DAMAGE DURING CONSTRUCTION.
- EXISTING GAS SERVICE. PROTECT FROM DAMAGE DURING CONSTRUCTION.
- EXISTING ELECTRICAL SERVICE. PROTECT FROM DAMAGE DURING CONSTRUCTION.
- EXISTING INTERNET CONNECTION TO BUILDING A. PROTECT FROM DAMAGE DURING CONSTRUCTION.
- EXISTING FENCE. PROTECT FROM DAMAGE DURING CONSTRUCTION.
- SP76 NEW FENCE AND GATE TO MATCH EXISTING CEDAR FENCE (BY OWNER.)
- SP77 NEW GATE MATCH EXISTING STYLE AND HARDWARE (BY OWNER.)




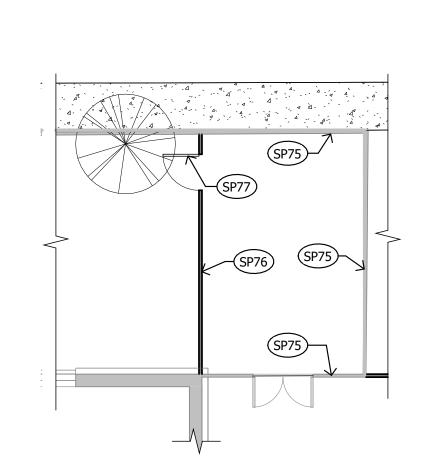

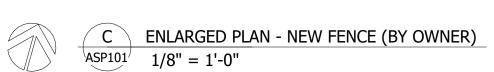

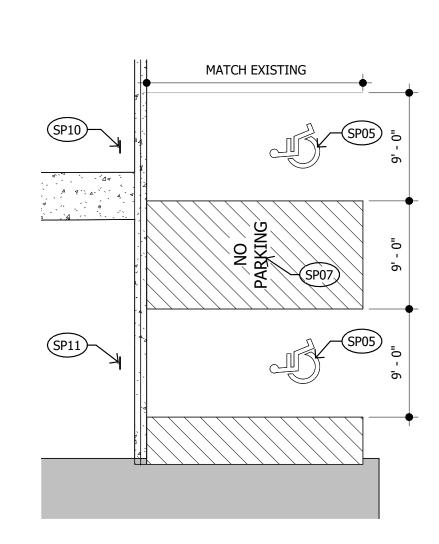

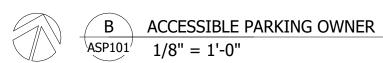

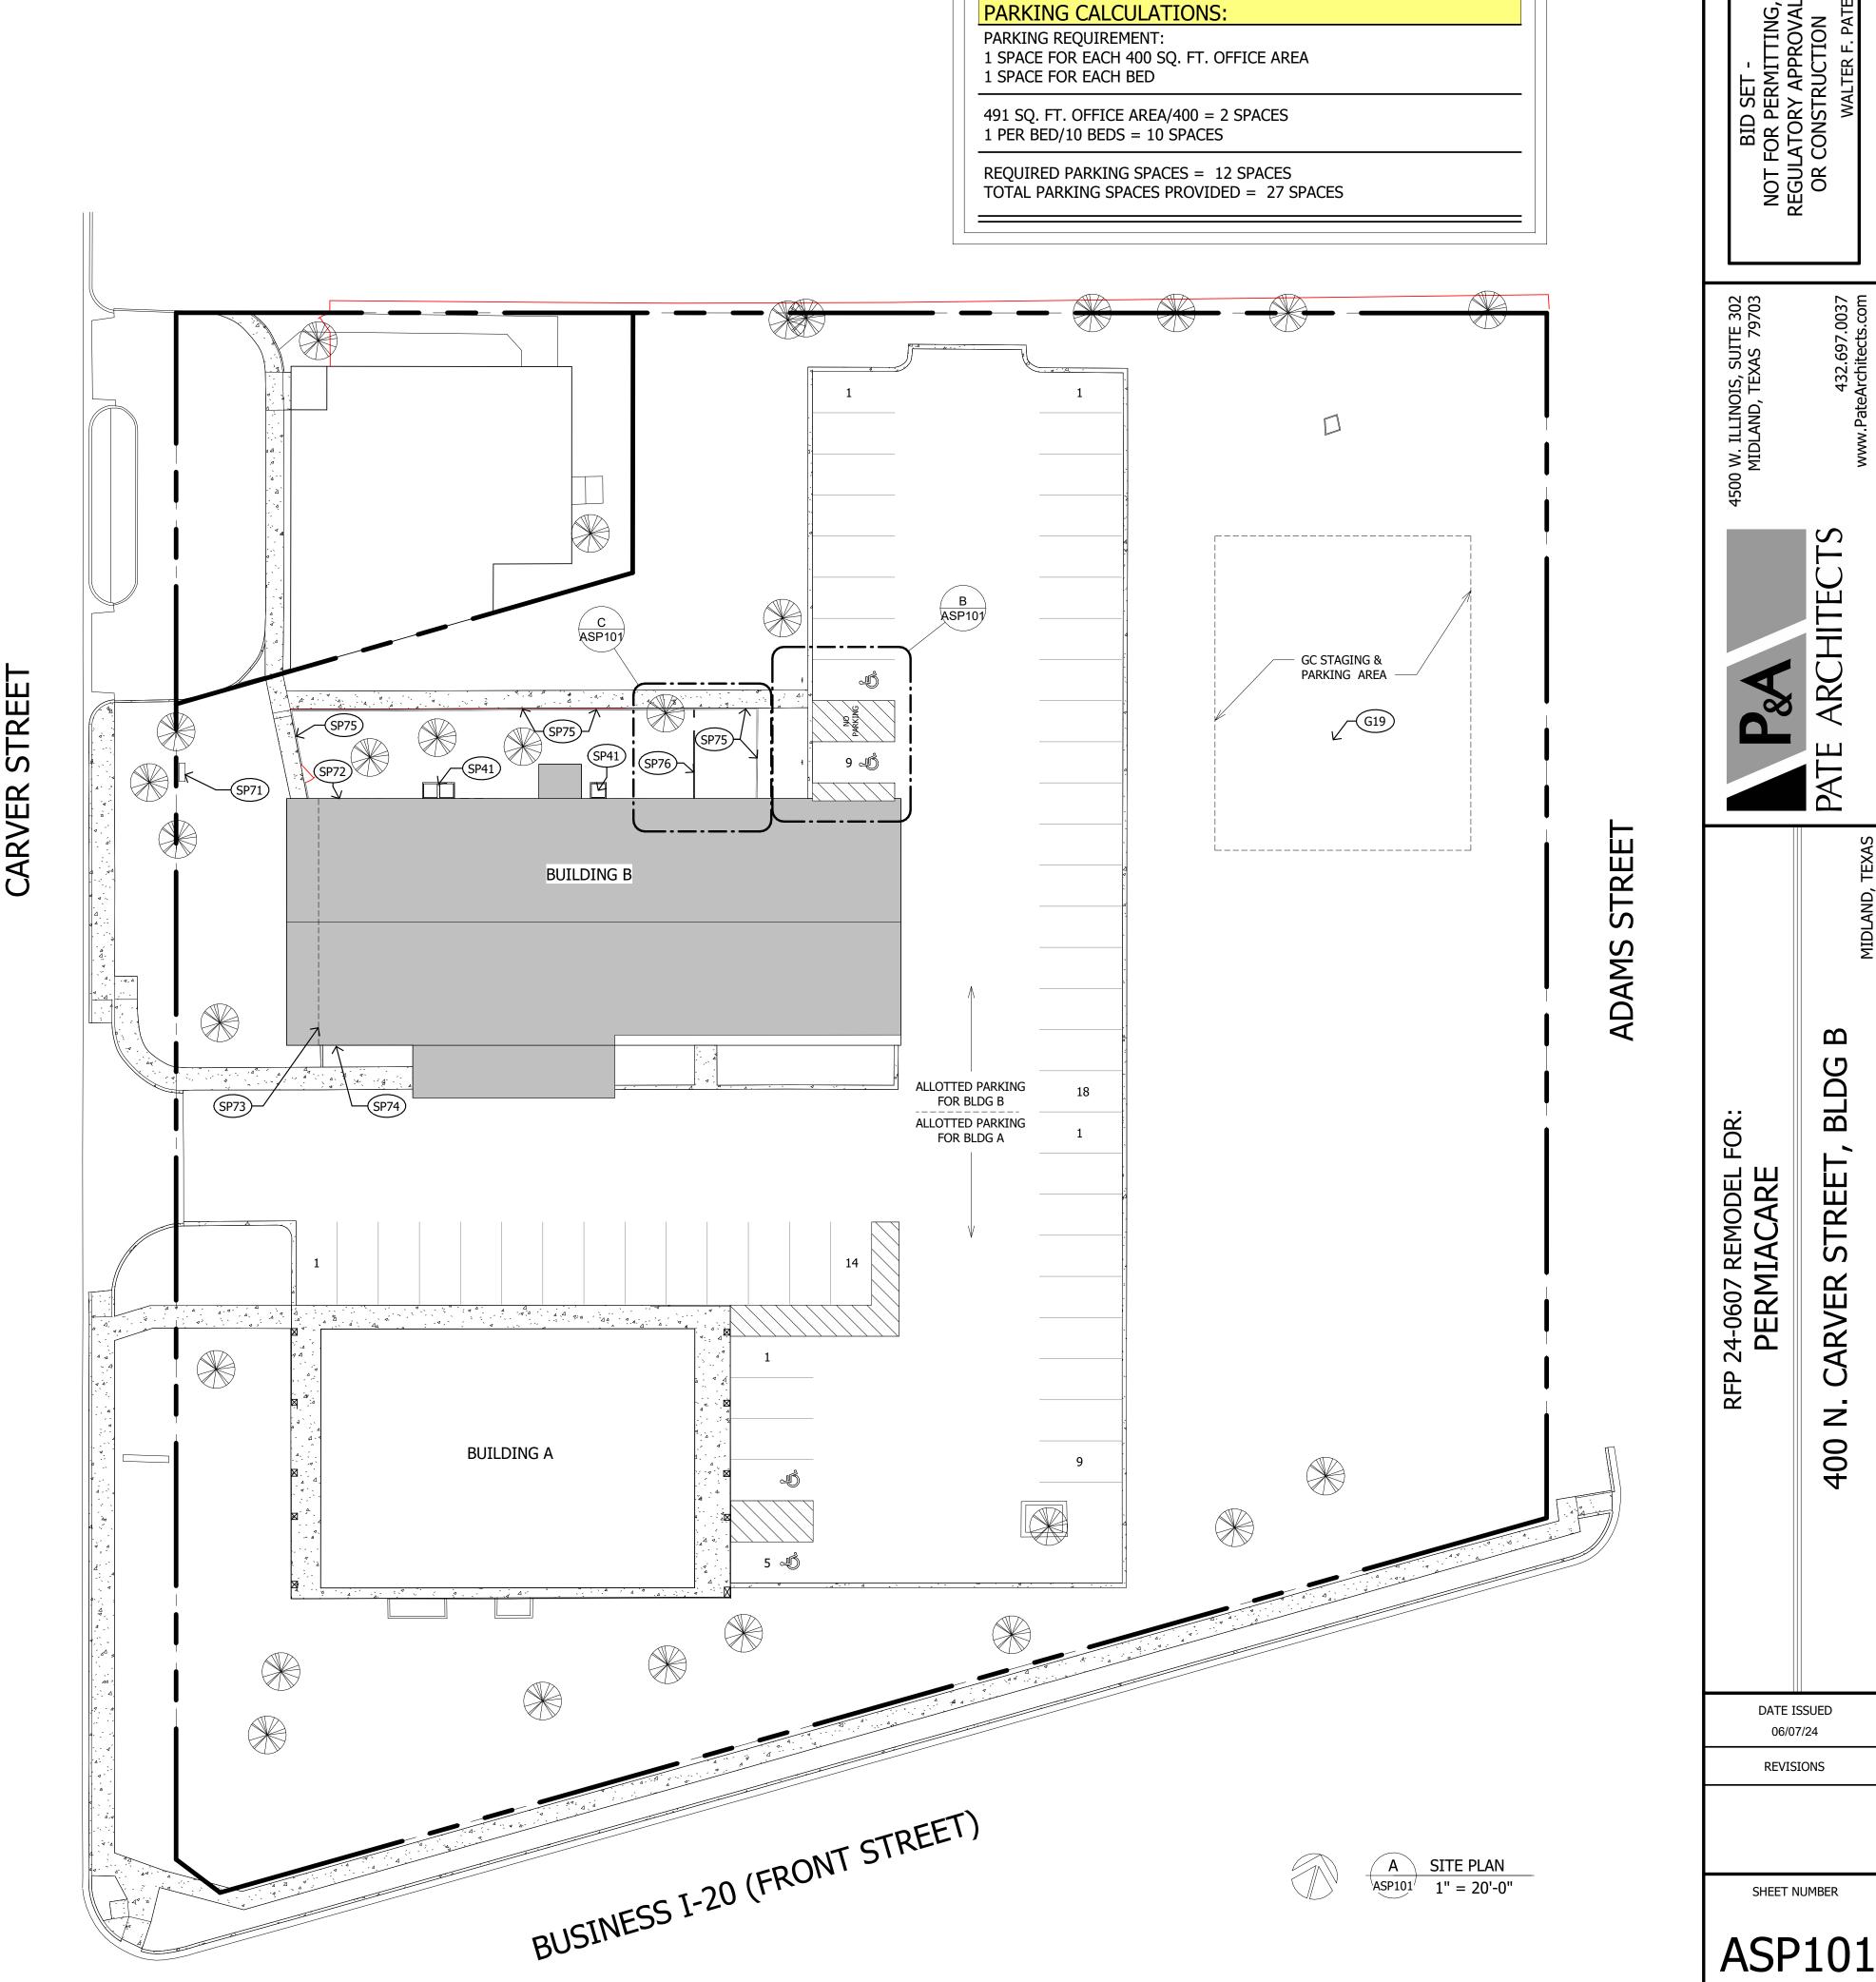

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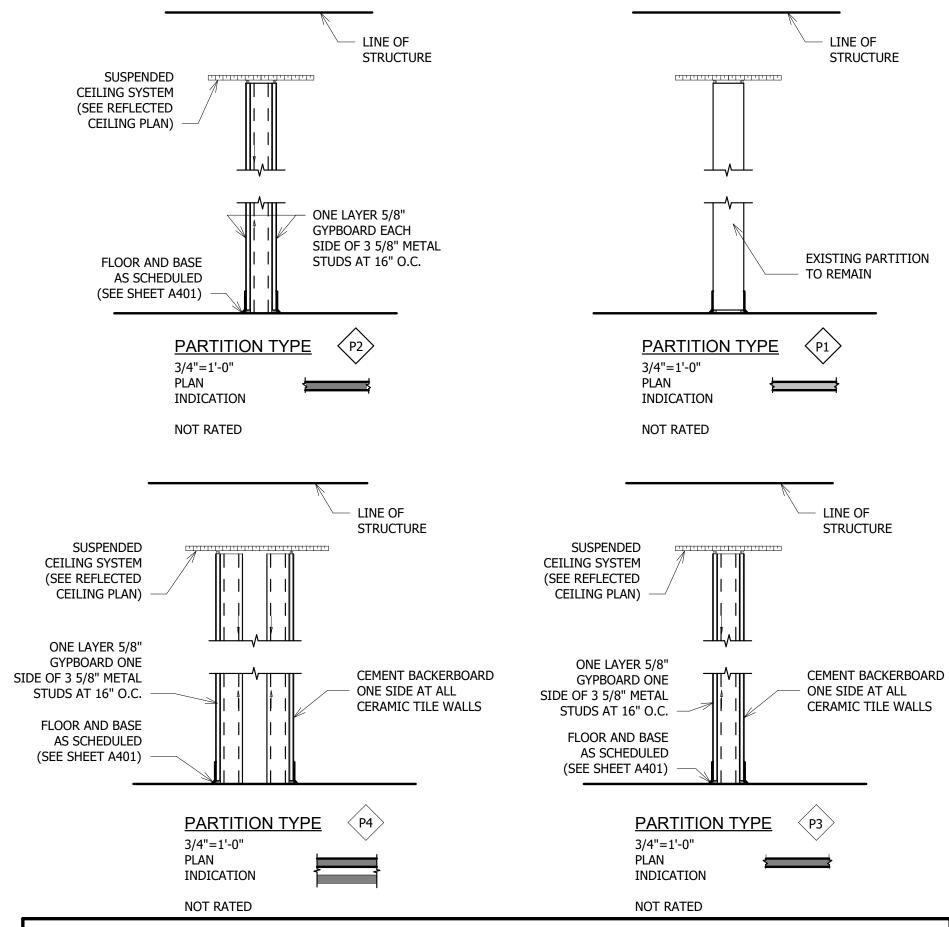
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GENERAL KEYNOTES

- ALL CONSTRUCTION TO COMPLY WITH LOCAL BUILDING CODES AND ORDINANCES AND REQUIREMENTS OF THE TEXAS ACCESSIBILITY STANDARDS (TAS).
- INFORMATION SHOWN REGARDING THE EXISTING BUILDING IS CORRECT TO THE BEST KNOWLEDGE AND BELIEF OF THE ARCHITECT. MINOR DISCREPANCIES MAY BE FOUND. THE GENERAL CONTRACTOR IS RESPONSIBLE FOR REVIEWING AND FIELD VERIFYING ALL CONDITIONS AT THE JOB SITE.
- THE FOLLOWING ITEMS ARE NOT INCLUDED IN THIS BID AND WILL BE COMPLETED BY OTHERS
- (GC TO COORDINATE WORK WITH SUB-CONTRACTORS:)
- 1.) EXISTING FENCE MODIFICATIONS AND NEW FENCED AREAS
- 2.) PAINTED STRIPING AND NEW SIGNAGE FOR ADA/TAS PARKING SPACES
- 3.) TEXTURE AND PAINTING OF ALL INTERIOR WALLS.


ARCHITECTURAL KEYNOTES


- A7 ALIGN FACE OF NEW WALL WITH THE FACE OF EXISTING WALL (TYPICAL).
- A12 ADA/TAS ACCESSIBLE ENTRANCE/EXIT.
- A50 INFILL OPENING (FROM DEMO OF DOOR OR WINDOW); MATCH ADJACENT EXTERIOR WALL CONSTRUCTION. TAPE BED AND FLOAT INTERIOR WALL CONSTRUCTION. TEXTURE AND PAINT BY OWNER.
- A53 INSTALL SALVAGED FIRE EXTINGUISHER.
- A55 EXISTING FIRE ALARM PANEL. PROTECT FROM DAMAGE DURING CONSTRUCTION.
- A61 NEW WINDOW COVERINGS TYPICAL AT ALL EXTERIOR WINDOWS.
- A71 NEW CEDAR FENCE. MATCH EXISTING. (BY OWNER)
- A72 EXISTING FENCE. PROTECT FROM DAMAGE DURING CONSTRUCTION.
- A73 NEW DOOR AND FRAME. SEE DOOR SCHEDULE. MEET TAS REQUIREMENTS.
- A74 NEW GATE MATCH EXISTING CEDAR FENCE. (BY OWNER)
- A75 EXISTING GATE MEET TAS REQUIREMENTS (BY OWNER.)


FIRE PROTECTION SPRINKLER SYSTEM KEYNOTES

- BUILDING IS PROTECTED BY AN AUTOMATIC FIRE PROTECTION SPRINKLER SYSTEM. MODIFY THE EXISTING SYSTEM TO ACCOMMODATE THE REVISED FLOOR PLAN CONFIGURATION.
- FP2 ALL NEW SPRINKLER HEADS TO COMPLY WITH NFPA 13. MATCH EXISTING HEADS. SUBMIT SHOP DRAWINGS OF SYSTEM MODIFICATIONS FOR APPROVAL

ALL INTERIOR SIGNAGE EQUAL TO

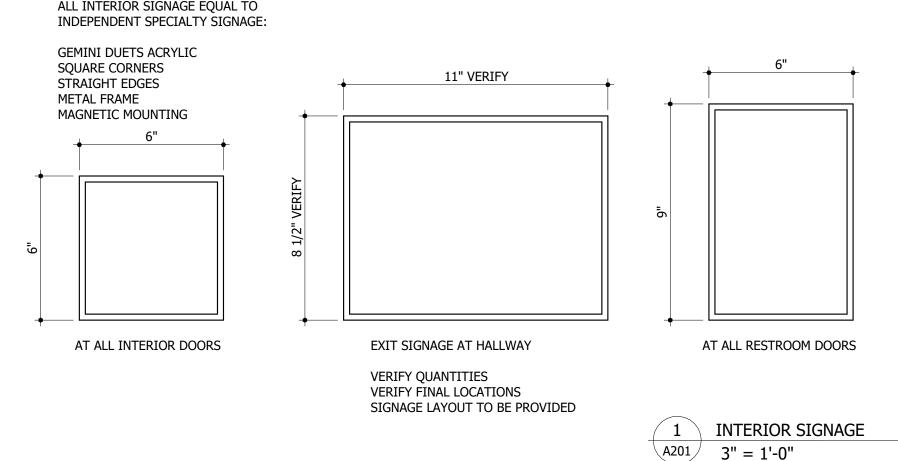

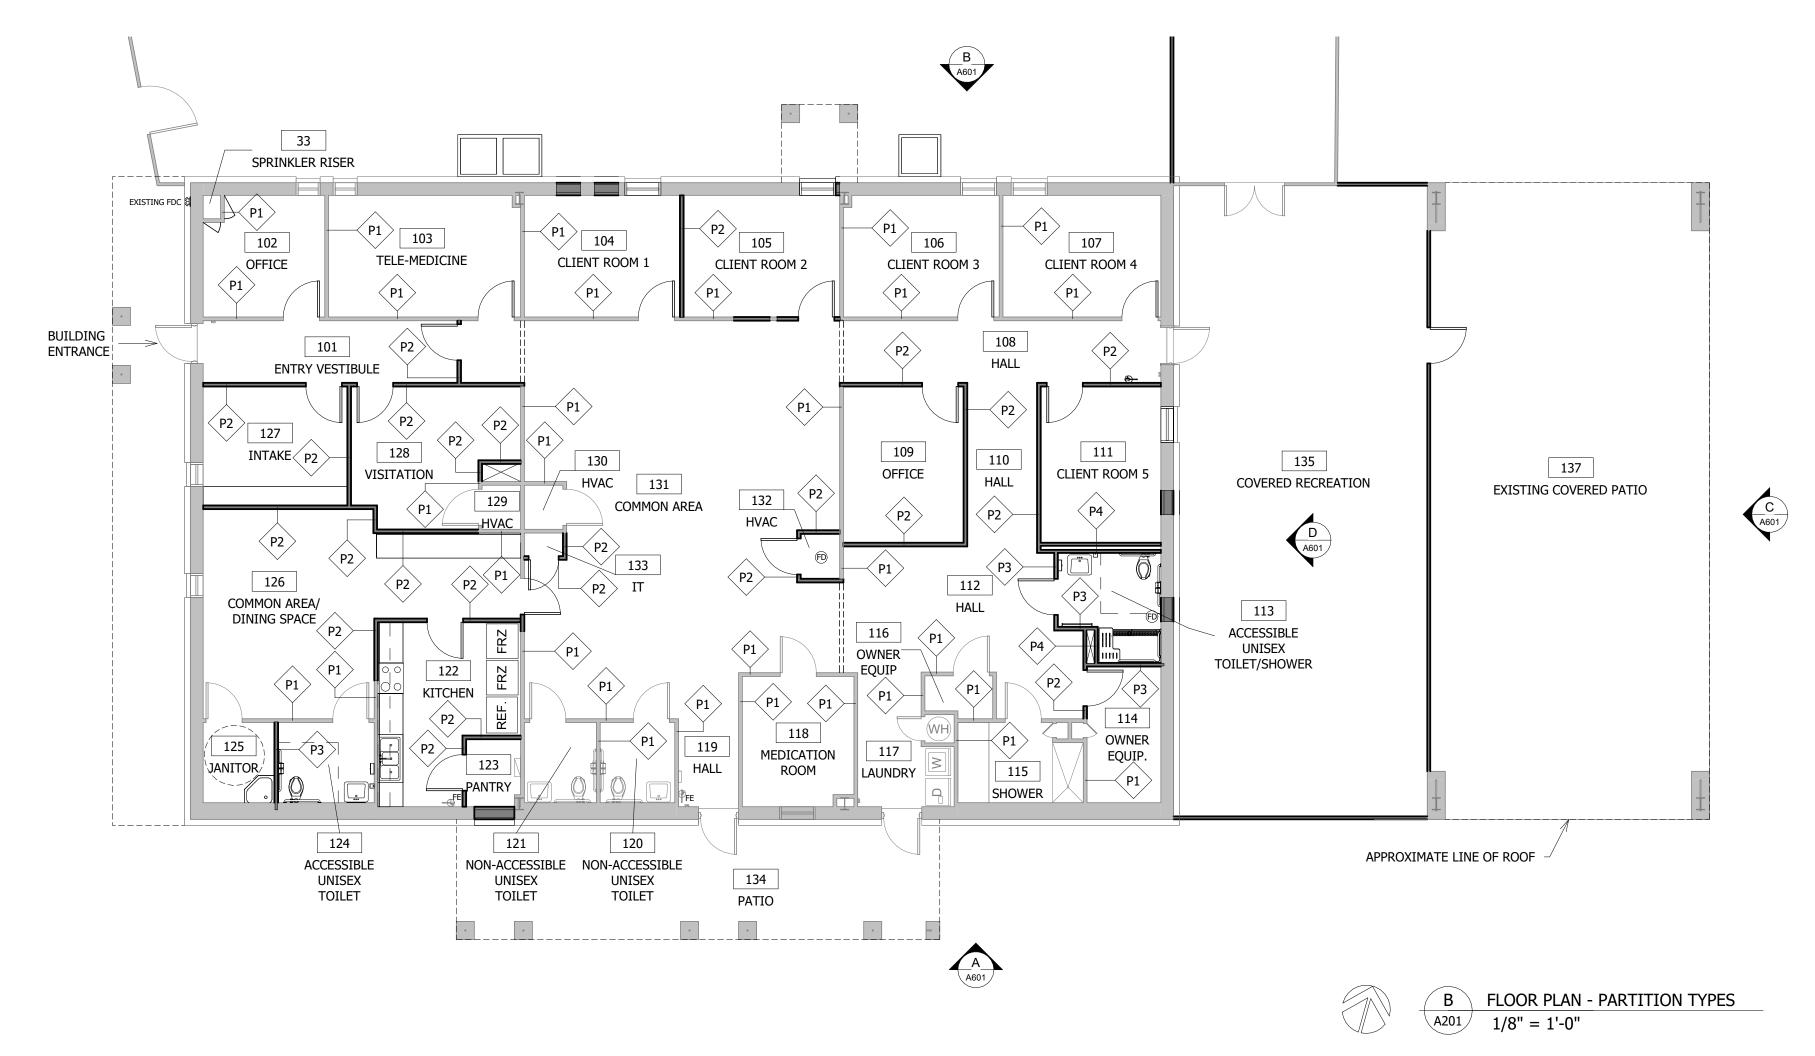

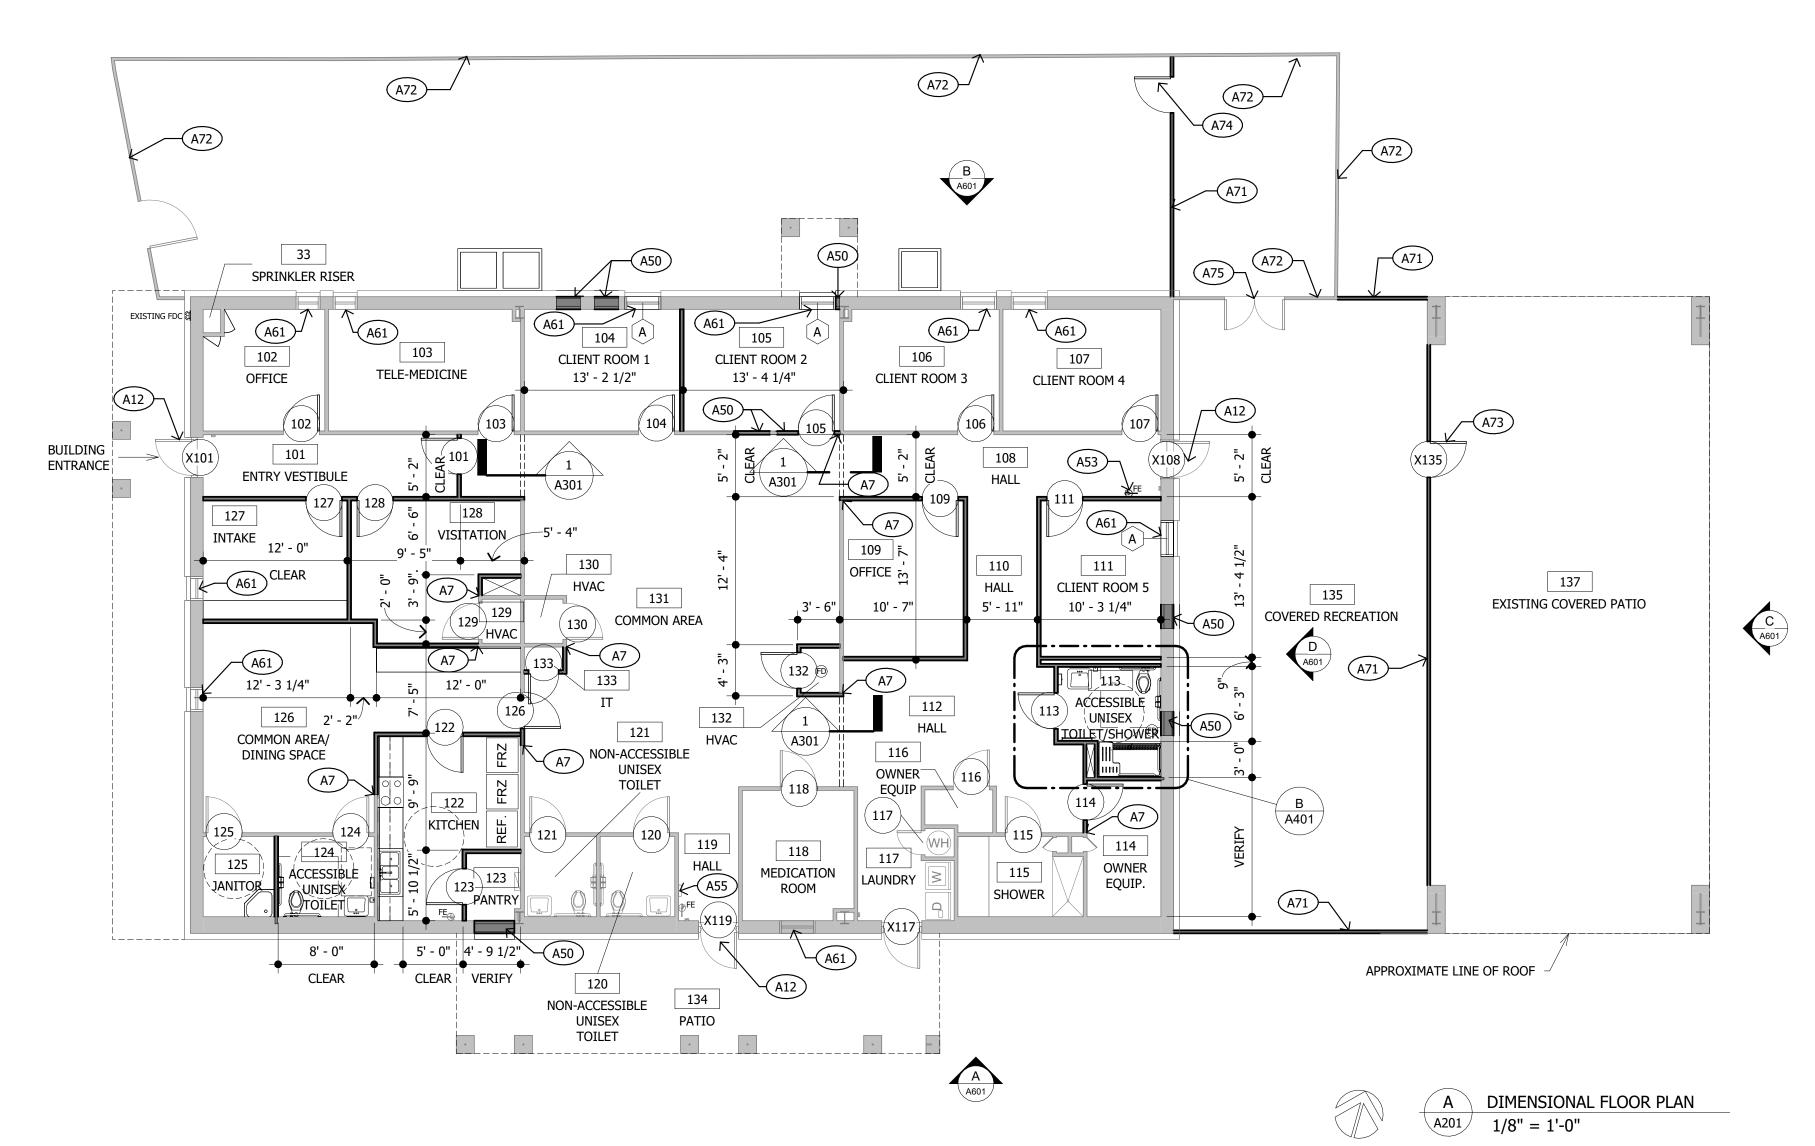

STREET 24-0607 REMODEL F
PERMIACARE DATE ISSUED 06/07/24 REVISIONS SHEET NUMBER A201

2401A

ARCHITECTURAL KEYNOTES

PROVIDE WOOD BLOCKING AS REQUIRED FOR ALL WALL MOUNTED MILLWORK.

REFLECTED CEILING KEYNOTES

GENERAL CONTRACTOR IS RESPONSIBLE FOR VERIFYING EXISTING CONDITIONS.

RE-USE EXISTING CEILING SUSPENSION SYSTEM AND CEILING TILE WHERE POSSIBLE. CUT SUSPENSION SYSTEM, TIE OFF, REWORK AND REPAIR CEILING SYSTEM AS REQUIRED FOR NEW CONSTRUCTION.

REPLACE EXISTING CEILING GRID AND TILE WHICH HAS BEEN DAMAGED OR STAINED.

RC13 REPLACE EXISTING 2 X 2 AND 2 X 4 FLUORESCENT LAY-IN LIGHT FIXTURE AND LENS WITH NEW 2 X 2 AND 2 X 4 LED FIXTURES.

AE 2 X 2 LED EMERGENCY FIXTURE

2 X 2 LED FIXTURE

2 X 4 LED FIXTURE

AIR SUPPLY DIFFUSER

AIR SUPPLY DIFFUSER

EXHAUST FAN

FIRE SPRINKLER HEAD

EXTERIOR WALL SCONCE

VANITY LIGHT BAR

REFLECTED CEILING PLAN NOTES:


EXISTING SUSPENDED CEILING TO REMAIN AS IS. REPLACE MISSING, BROKEN OR STAINED CEILING TILES.

REPLACE EXISTING SUSPENDED CEILING WITH WATER RESISTANT GYPROARD

E = EXISTING FIXTURE

33 SPRINKLER RISER 〈 C1 〉 103 • E 105 • E 107 ●E 104 106 TELE-MEDICINE N CLIENT ROOM 1 CLIENT ROOM 2 CLIENT ROOM 3 CLIENT ROOM 4 BUILDING ENTRANCE 127 •_E C1 INTAKE VISITATION 109 CLIENT ROOM 5 137 135 COVERED RECREATION EXISTING COVERED PATIO 132 COMMON AREA 113 ACCESSIBLE UNISEX 112 126 ●_E E TOILET/SHOWER $\langle C1 \rangle$ COMMON AREA/ DINING SPACE HALL OWNER KITCHEN LAUNDRY R SHOWER 125 JANITOR 118 124 120 PANTRY 121 NON-ACCESSIBLE HALL

NON-ACCESSIBLE UNISEX
TOILET MEDICATION ROOM ACCESSIBLE UNISEX TOILET PATIO A REFLECTED CEILING PLAN
1/8" = 1'-0"

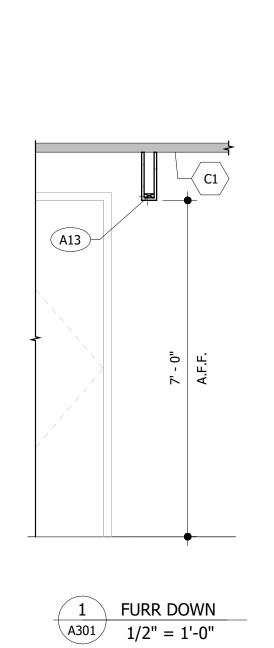

RESISTANT GYPBOARD.

D = DEMO EXISTING FIXTURE

N = NEW FIXTURE

R = NEW FIXTURE AT EXISTING LOCATION

FOR: PERMIACARE

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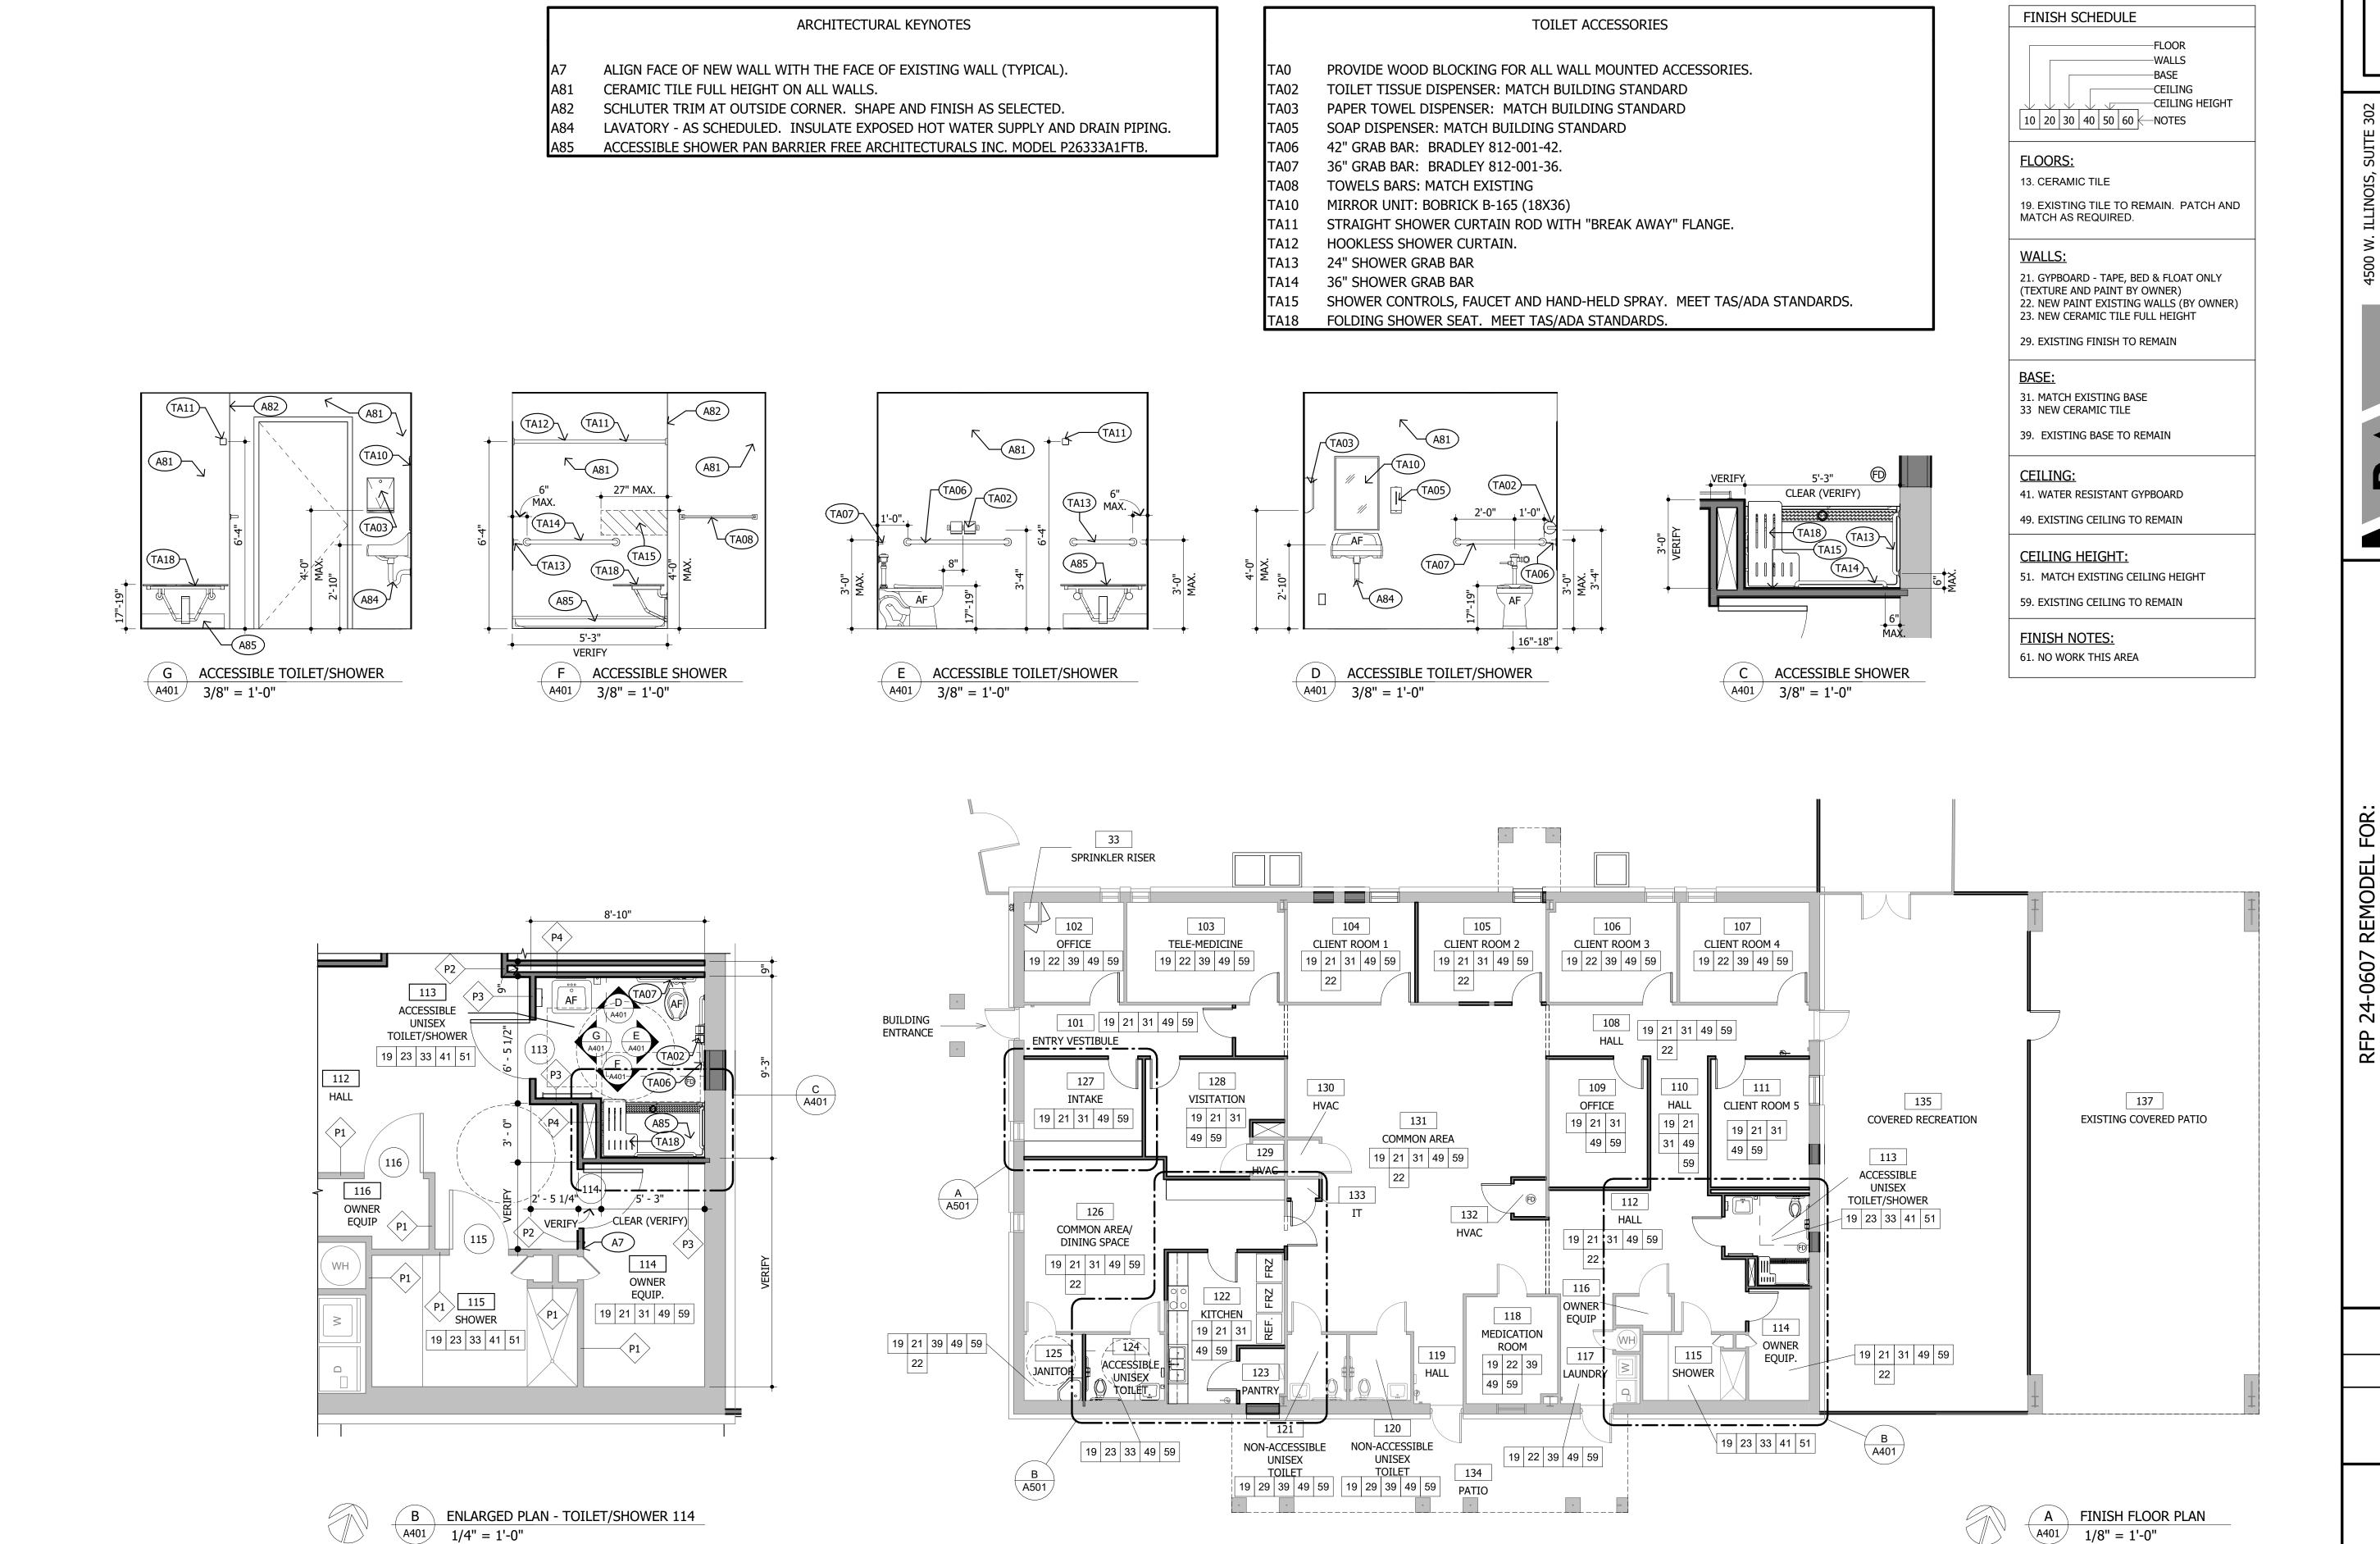
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REVISIONS

SHEET NUMBER

A401

ARCHITECTURAL KEYNOTES


- ALIGN FACE OF NEW WALL WITH THE FACE OF EXISTING WALL (TYPICAL).
- PROVIDE WOOD BLOCKING AS REQUIRED FOR ALL WALL MOUNTED MILLWORK.
- CERAMIC TILE FULL HEIGHT ON ALL WALLS.


TOILET ACCESSORIES


- PROVIDE WOOD BLOCKING FOR ALL WALL MOUNTED ACCESSORIES.
- TA02 TOILET TISSUE DISPENSER: MATCH BUILDING STANDARD
- PAPER TOWEL DISPENSER: MATCH BUILDING STANDARD
- TA05 SOAP DISPENSER: MATCH BUILDING STANDARD
- 42" GRAB BAR: BRADLEY 812-001-42.
- TA07 36" GRAB BAR: BRADLEY 812-001-36.
- TA10 MIRROR UNIT: BOBRICK B-165 (18X36)


MILLWORK KEYNOTES


- MW01 VERIFY ALL DIMENSIONS IN THE FIELD PRIOR TO FABRICATION.
- SUBMIT MILLWORK SHOP DRAWINGS & MATERIAL SAMPLES AS SELECTED.
- ALL MILLWORK MATERIALS, HARDWARE, AND FINISHES, ETC. TO BE SELECTED AND APPROVED BY ARCHITECT.
- MW14 PLASTIC LAMINATE FINISH OVER PLYWOOD SUBSTRATE; MATCH EXISTING.
- MW20 SET BACK SPLASH AND SIDE SPLASH IN BEAD OF SILICONE SEALANT. PRESS SPLASH FIRMLY IN PLACE, FORCE EXCESS SEALANT OUT OF THE JOINT. AFTER SEALANT SETS CLEAN OFF EXCESS.
- MW22 SOLID SURFACE COUNTER TOP & SPLASH (ABOUT 1/2" THICK) OVER 3/4" PLYWOOD SUBSTRATE.
- MW31 TOE SPACE WITH BASE AS SPECIFIED.
- MW32 SCHEDULED BASE.
- HINGES: CONCEALED, SELF-CLOSING WITH BUMPERS, 1-PAIR AT DOORS UP TO 30" HIGH; 1-1/2 PAIR AT DOORS GREATER THAN 30" HIGH.
- MW42 PULLS: 1 PER DRAWER AND 1 PER DOOR.
- MW44 DRAWER SLIDES: 1-PAIR, FULL EXTENSION, GUIDES PER DRAWER; SELF CLOSING.
- MW46 LOCKING DRAWER
- ADJUSTABLE SHELVES; FLUSH MOUNTED K&V 255 VERTICAL STANDARDS WITH #256 CLIPS (OR APPROVED EQUAL).
- MW56 REMOVABLE KNEE SPACE PANEL: 3/4" HARDWOOD PLYWOOD; SPECIES AND FINISH PLASTIC LAMINATE. ATTACH USING 1X2 WOOD CLEATS WITH SCREWS AND FINISH WASHERS (2 PER END).
- MW81 RETURN AIR GRILLE.
- MW802 REFRIGERATOR BY OWNER.
- MW808 RANGE BY OWNER.
- MW809 FREEZER BY OWNER.
- MW812 TYPE II "DUCTLESS" EXHAUST HOOD VERIFY SIZE.
- MW816 PROVIDE THREE COMPARTMENT SINK AND GOOSENECK FAUCET.

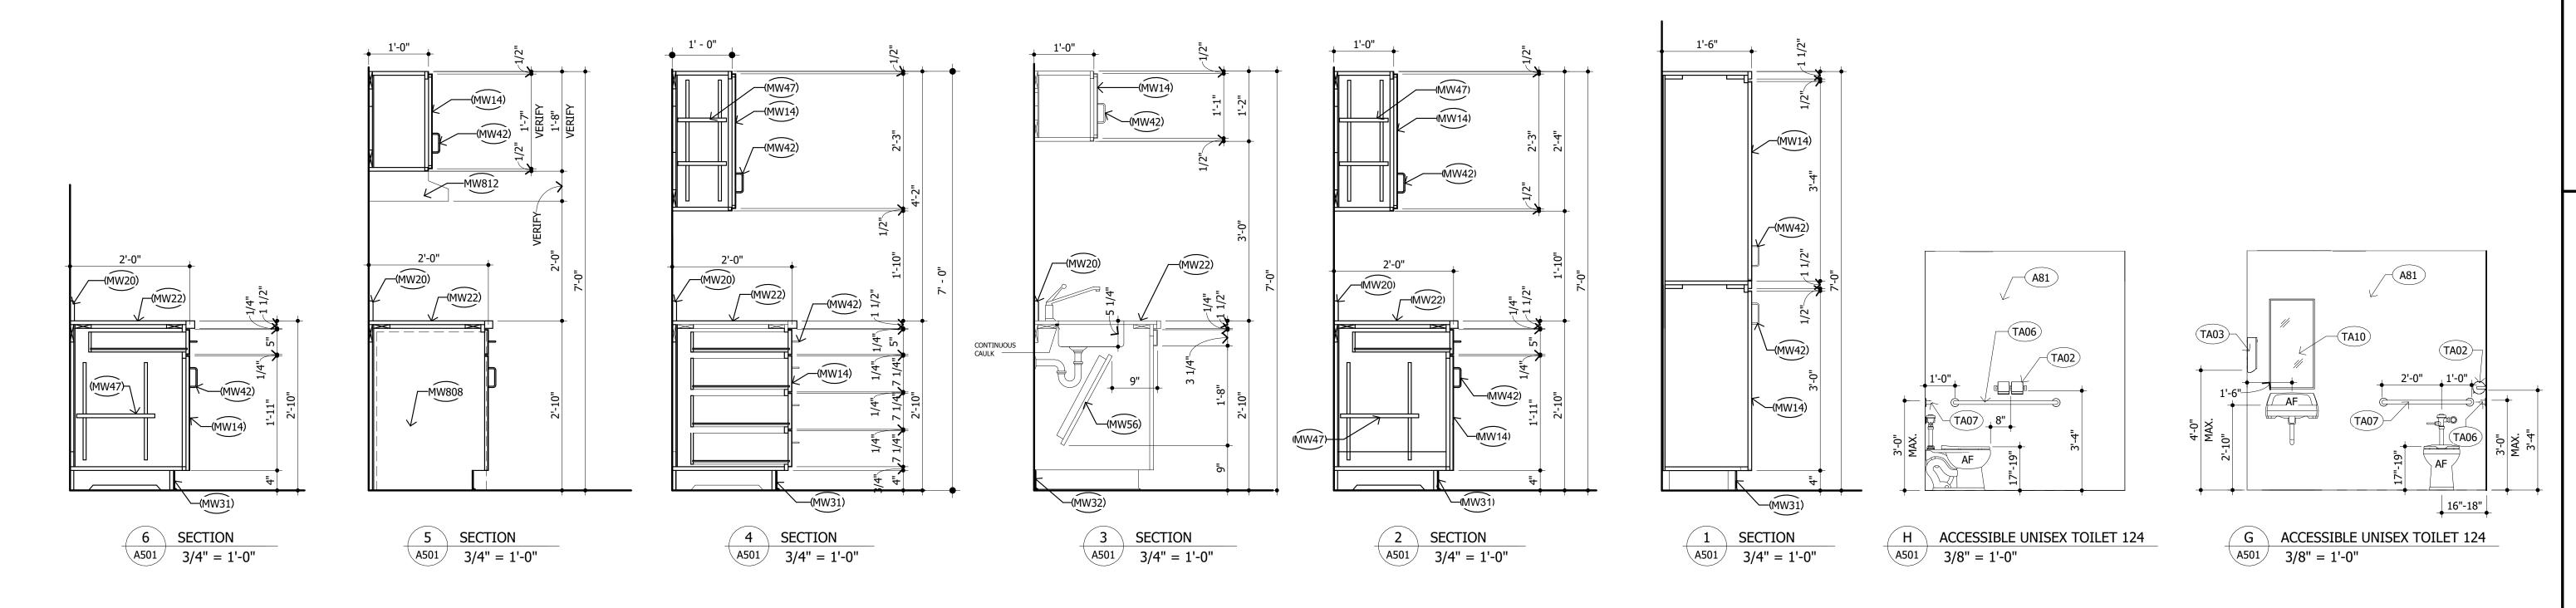


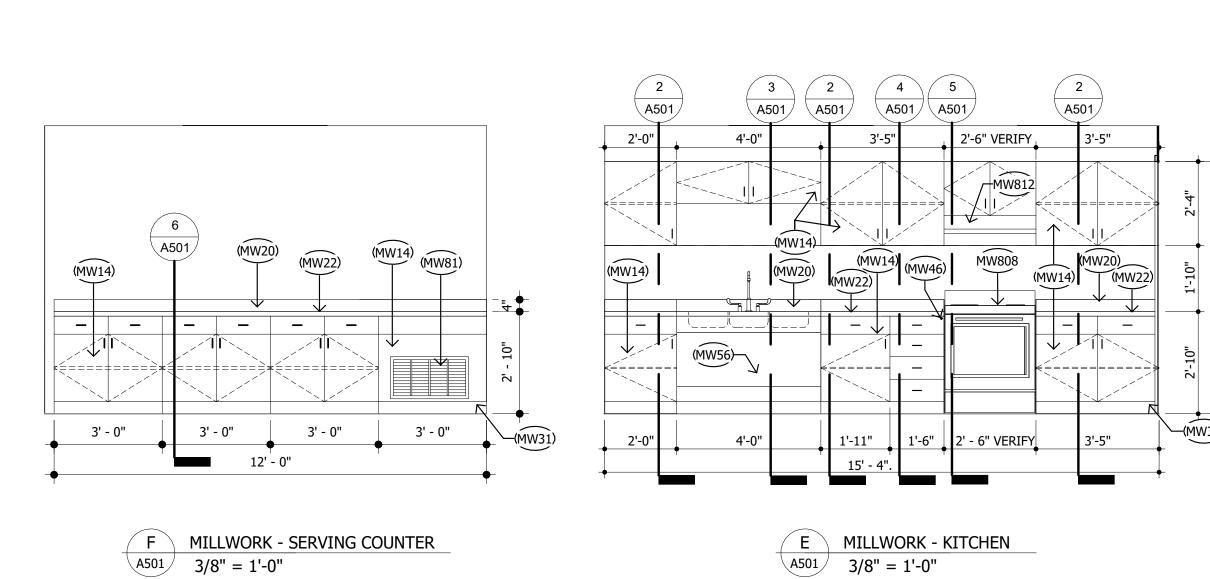

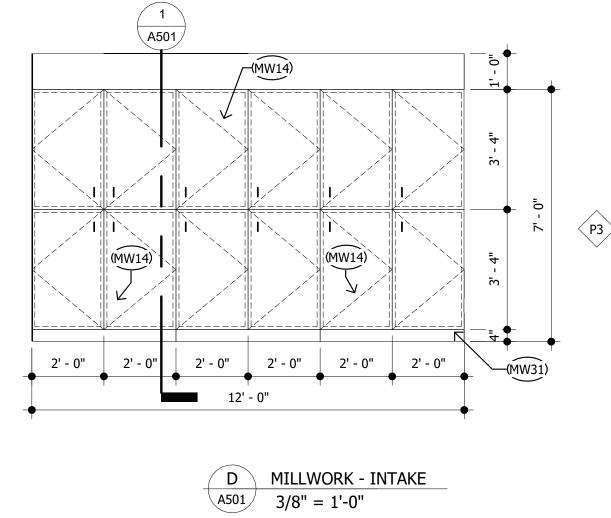

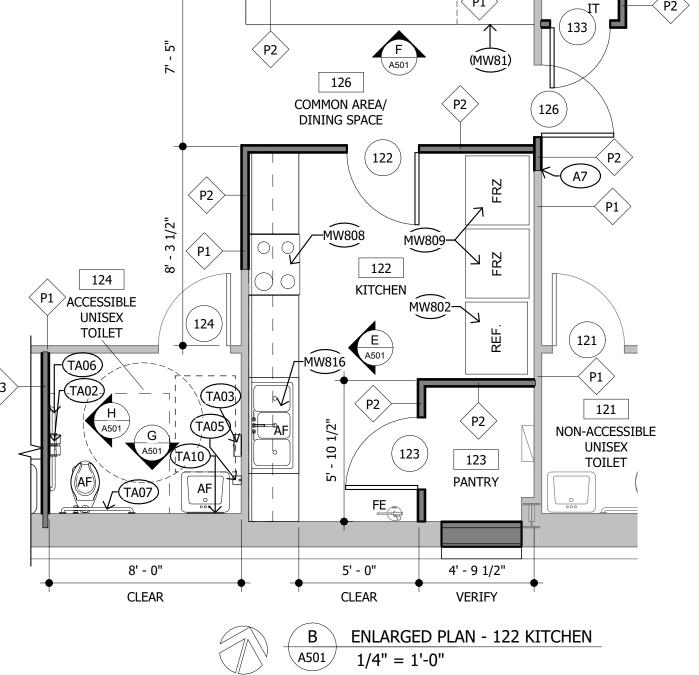

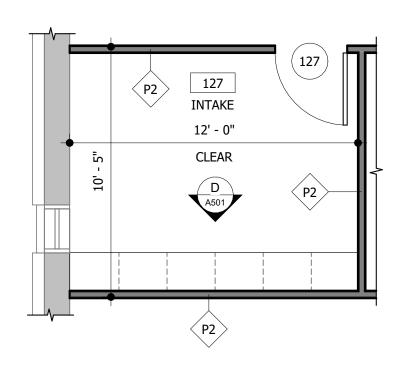

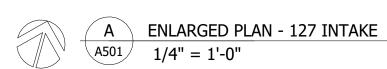

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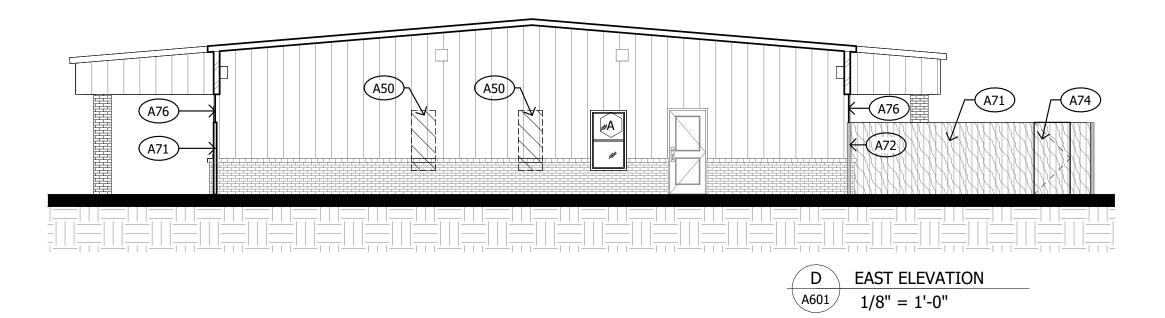
REVISIONS


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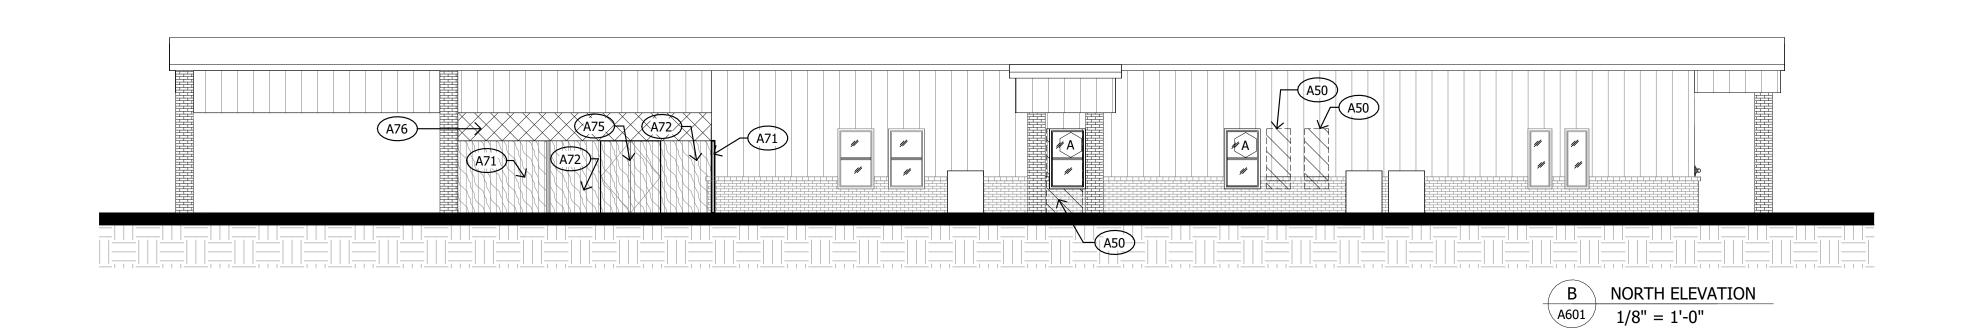
A501


ARCHITECTURAL KEYNOTES

- INFILL OPENING (FROM DEMO OF DOOR OR WINDOW); MATCH ADJACENT EXTERIOR WALL CONSTRUCTION. TAPE, BED AND FLOAT INTERIOR WALL CONSTRUCTION. TEXTURE AND PAINT BY OWNER.
- A71 NEW CEDAR FENCE. MATCH EXISTING. (BY OWNER)
- A72 EXISTING FENCE. PROTECT FROM DAMAGE DURING CONSTRUCTION.
- A73 NEW DOOR AND FRAME. SEE DOOR SCHEDULE. MEET TAS REQUIREMENTS.
- NEW GATE MATCH EXISTING CEDAR FENCE. (BY OWNER)
- EXISTING GATE MEET TAS REQUIREMENTS (BY OWNER.)
- 6 X 6 10/10 W.W.M. CUT AND ATTACH AS REQUIRED (BY OWNER.)





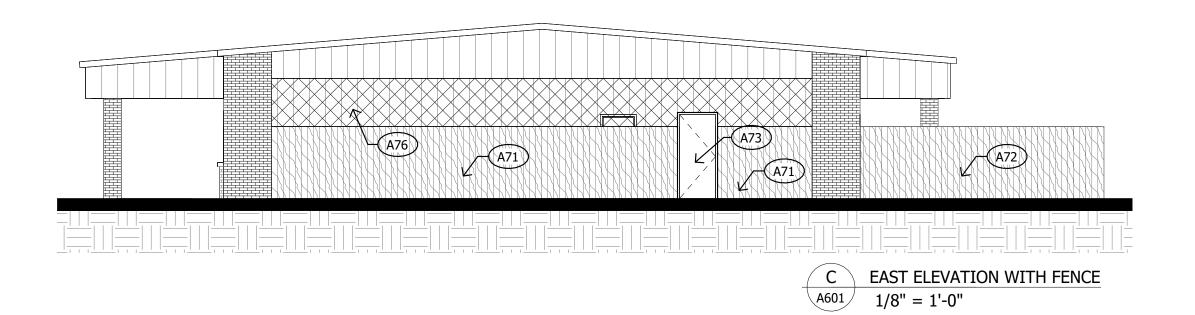

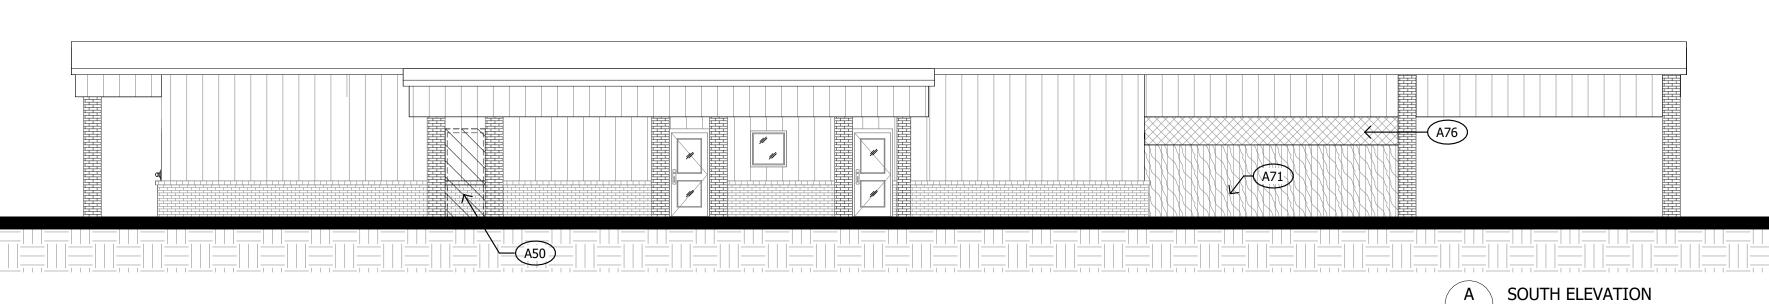

A SOUTH ELEVATION
A601 1/8" = 1'-0"

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RFP 24-0607 REMODEL FOR: PERMIACARE STREET,

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SHEET NUMBER A601


									DOOR	SCHEDUL	E						
										HAR	DWARE						
	EXISTING EXISTING	NEW	NEW					ANTI-LIGATURE	ANTI-LIGATURE	ANTI-LIGATURE	ELECTRIC	SPRING LOADED		1-1/2 PAIR		PANIC	
MARK				SIZE	RATING	FINISH	LOCKSET LATCHSET	LOCKSET	LATCHSET	PRIVACY SET	STRIKE	HINGES	CLOSER	BUTTS	STOP	DEVICE	NOTES
L		1	1				1						1		1	1	
101		X	X	MATCH EXISTING		CLEAR (NOTE 2)		Χ			X	X		X	X	X	NOTE 1
102	X	X		MATCH	20 MIN.	CLEAR (NOTE 2)	Х						X	X	X		
103	X	X		EXISTING MATCH	20 MIN.	CLEAR (NOTE 2)		X				X		X	X		
104	X	X		EXISTING MATCH	20 MIN.	CLEAR (NOTE 2)			X			X		X	X		
105		X	X	EXISTING MATCH		CLEAR (NOTE 2)			X			X		X	X		
105				EXISTING	2011111							,					
106	X	X		MATCH EXISTING	20 MIN.	CLEAR (NOTE 2)			X			X		X	X		
107	X	X		MATCH	20 MIN.	CLEAR (NOTE 2)			X			X		X	X		
109		X	X	EXISTING MATCH	20 MIN.	CLEAR (NOTE 2)			X			X		X	X		
111		X	X	EXISTING MATCH	20 MIN.	CLEAR (NOTE 2)			X			X		X	X		
113		X	X	EXISTING MATCH		CLEAR (NOTE 2)				X		X		X	X		
114		X	X	EXISTING MATCH		CLEAR (NOTE 2)		X				X		X	X		
	V V	, A	, A	EXISTING				, , , , , , , , , , , , , , , , , , ,		V							
115	X X					NOTE 2				X		X		X	X		
116	X X					NOTE 2		X				X		X	X		
117	X X					NOTE 2		X				X		X	X		NOTE 1
118	X X					NOTE 2		X			X	X		X	X		NOTE 1
120	X X					NOTE 2				X		^		X	X		
121	X X		.,	=		NOTE 2				X		X		X	X		110== 1
.22		X	X	MATCH EXISTING		CLEAR (NOTE 2)		Х			X	X		X	X		NOTE 1
.23		X	X	MATCH EXISTING		CLEAR (NOTE 2)		X				X		X	X		
24	X X					NOTE 2				X		X		X	Х		
L25	X X					NOTE 2		Х				X		Х	Х		
126		Х	Х	MATCH EXISTING		CLEAR (NOTE 2)		Х			X	X		X	Х		NOTE 1
.27		X	X	MATCH EXISTING	20 MIN.	CLEAR (NOTE 2)	Х						X	X	X		
128		X	X	MATCH	20 MIN.	CLEAR (NOTE 2)	Х						X	X	X		
20	V			EXISTING		NOTE 2	V										EVICTING LINGES TO DEMAIN
129	XXX					NOTE 2	X	V				V		V	V		EXISTING HINGES TO REMAIN
130	X X					NOTE 2		X				X		X	X		NOTE 2
132	XXX	\ \ \ \ \ \ \ \ \ \ \ \ \ \ \ \ \ \ \	\ \ \ \ \ \ \ \ \ \ \ \ \ \ \ \ \ \ \	NOTE 4		NOTE 2		X				X		X	X		NOTE 3
L33	V V	X	X	NOTE 4		CLEAR (NOTE 2)		X			V	X		X	X		NOTE 1 EVICTING HARDWARD TO REMARK AS TO
X101	X					NOTE 2					X						NOTE 1, EXISTING HARDWARE TO REMAIN AS IS
X108	X X					NOTE 2					X						NOTE 1, EXISTING HARDWARE TO REMAIN AS IS
X117	X X					NOTE 2											EXISTING HARDWARE TO REMAIN AS IS
X119	X X					NOTE 2											EXISTING HARDWARE TO REMAIN AS IS
X135		X	X	MATCH EXISTING		CLEAR (NOTE 2)		X			X	X		X	X	X	INSTALLED AT FENCE (PAINT TO MATCH BY OWNER)

NOTE 1: GC MODIFY FRAME AS REQUIRED FOR ELECTRIC STRIKE. CARD READER AND ELECTRIC STRIKE PROVIDED & INSTALLED BY OWNER.

NOTE 2: PAINTED FINISH BY OWNER.

NOTE 3: REUSE SALVAGED DOOR & FRAME FROM HVAC CLOSET #3.

NOTE 4: IT CLOSET DOOR 133 MATCH EXISTING DOOR AND FRAME HEIGHT. DOOR WIDTH 2'-6".

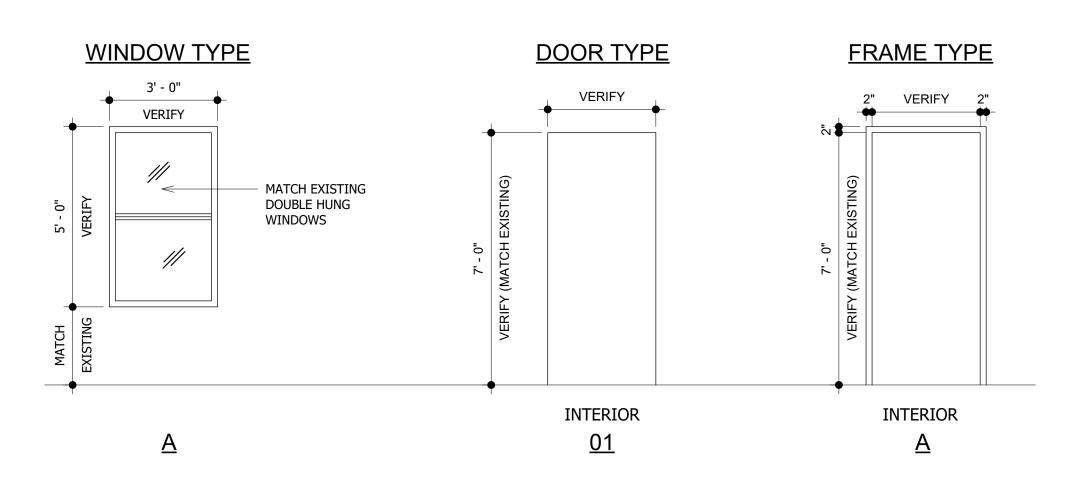

BID SET NOT FOR PERMITTING,
REGULATORY APPROVAL,
OR CONSTRUCTION
WALTER F. PATE, AIA

MIDLAND, TEXAS 79703

P&A

ATE ARCHITECTS

RFP 24-0607 REMODEL FOR:
PERMIACARE

N. CARVER STREET, BLDG

DATE ISSUED
06/07/24
REVISIONS

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SHEET NUMBER


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JOB NO. 2401A

NOTE: THIS PROJECT QUALIFIES FOR AN EXEMPTION TO CHAPTER C408.2 OF THE 2015 IECC AS THE HVAC AND SERVICE WATER HEATING SYSTEM CAPACITIES ARE BELOW THE MINIMUM REQUIREMENTS.

MECHANICAL KEYNOTES

- M1 ALL MECHANICAL CONSTRUCTION (HVAC, PLUMBING, ETC.) TO COMPLY WITH LOCAL BUILDING CODES AND ORDINANCES.
- M3 VERIFY ALL EXISTING CONDITIONS.
- M4 PROVIDE DESIGN LAYOUT FOR ALL MODIFICATIONS TO THE EXISTING HVAC SYSTEM FOR THE ARCHITECT AND BUILDING OWNER'S APPROVAL.
- REUSE EXISTING HVAC SYSTEM DUCT, REGISTERS, GRILLS, AND THERMOSTATS, ETC., OR IF NEW MATERIALS ARE REQUIRED THEN MATCH EXISTING.
- WHEN COMPLETE, BALANCE HVAC SYSTEM.
- M11 COORDINATE EXACT LOCATIONS OF CEILING DIFFUSERS AND GRILLES WITH ELECTRICAL/REFLECTED CEILING PLAN.
- M12 COORDINATE EXACT ROUTING OF DUCTWORK ABOVE CEILING WITH STRUCTURAL FRAMING MEMBERS. VERIFY SIZES AND LOCATION OF FRAMING MEMBERS.
- M26 VERIFY LOCATION FOR THERMOSTATS.
- M31 EXISTING CONDENSATION UNIT.
- M32 RELOCATE SALVAGED HVAC UNIT. PROVIDE PLATFORM (MATCH EXISTING.)
- M33 TIE VENTS FROM NEW HVAC LOCATION INTO EXISTING VENTS.
- M34 PROVIDE PLATFORM FOR IT CLOSET. MATCH PLATFORM IN EXISTING HVAC CLOSETS.
- M35 WALL MOUNTED RETURN AIR GRILLE. MATCH EXISTING.
- M36 RETURN AIR GRILLE. REFER TO REFLECTED CEILING PLAN.
- M37 PROVIDE DUCTWORK FOR RETURN AIR.
- M38 RETURN AIR GRILLE MOUNTED IN MILLWORK. MATCH EXISTING.

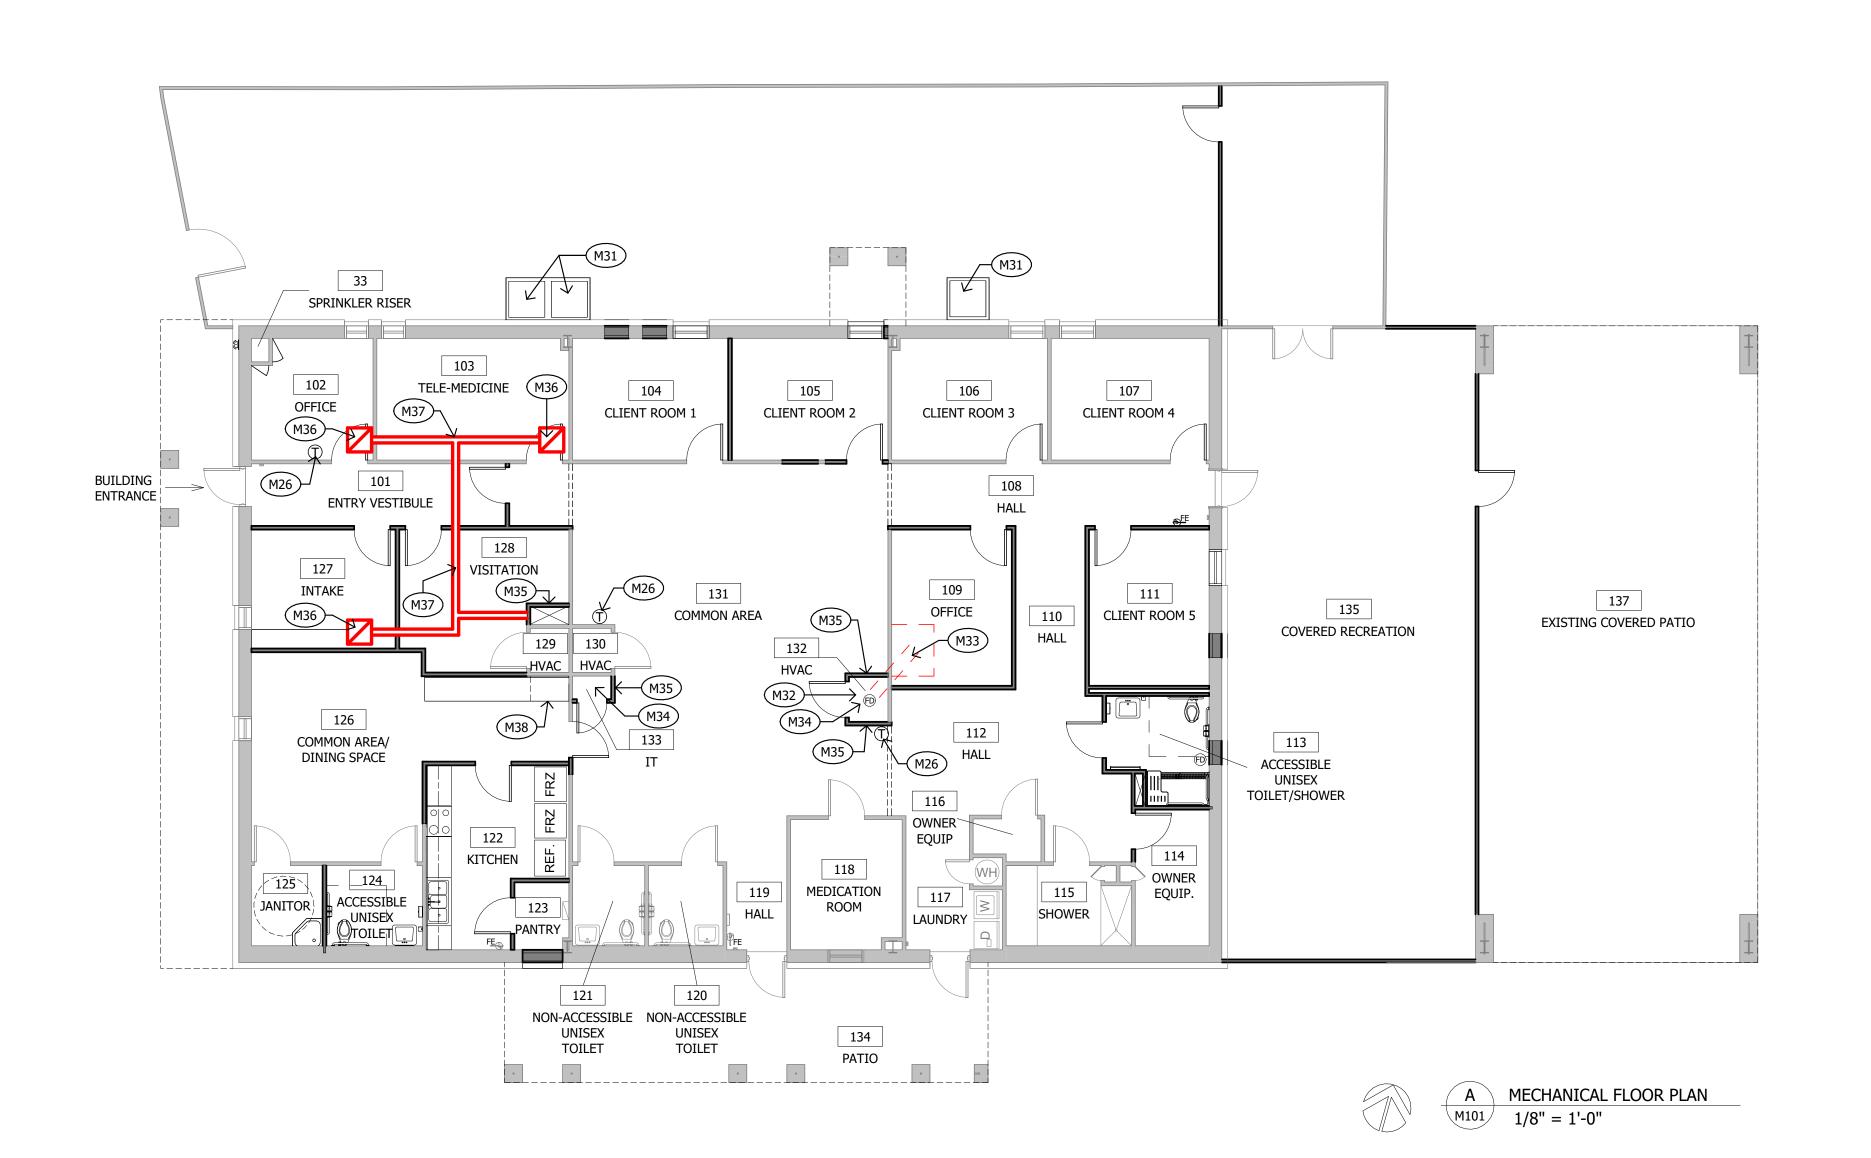

BLDG STREET,

RFP 24-0607 REMODEL
PERMIACARE

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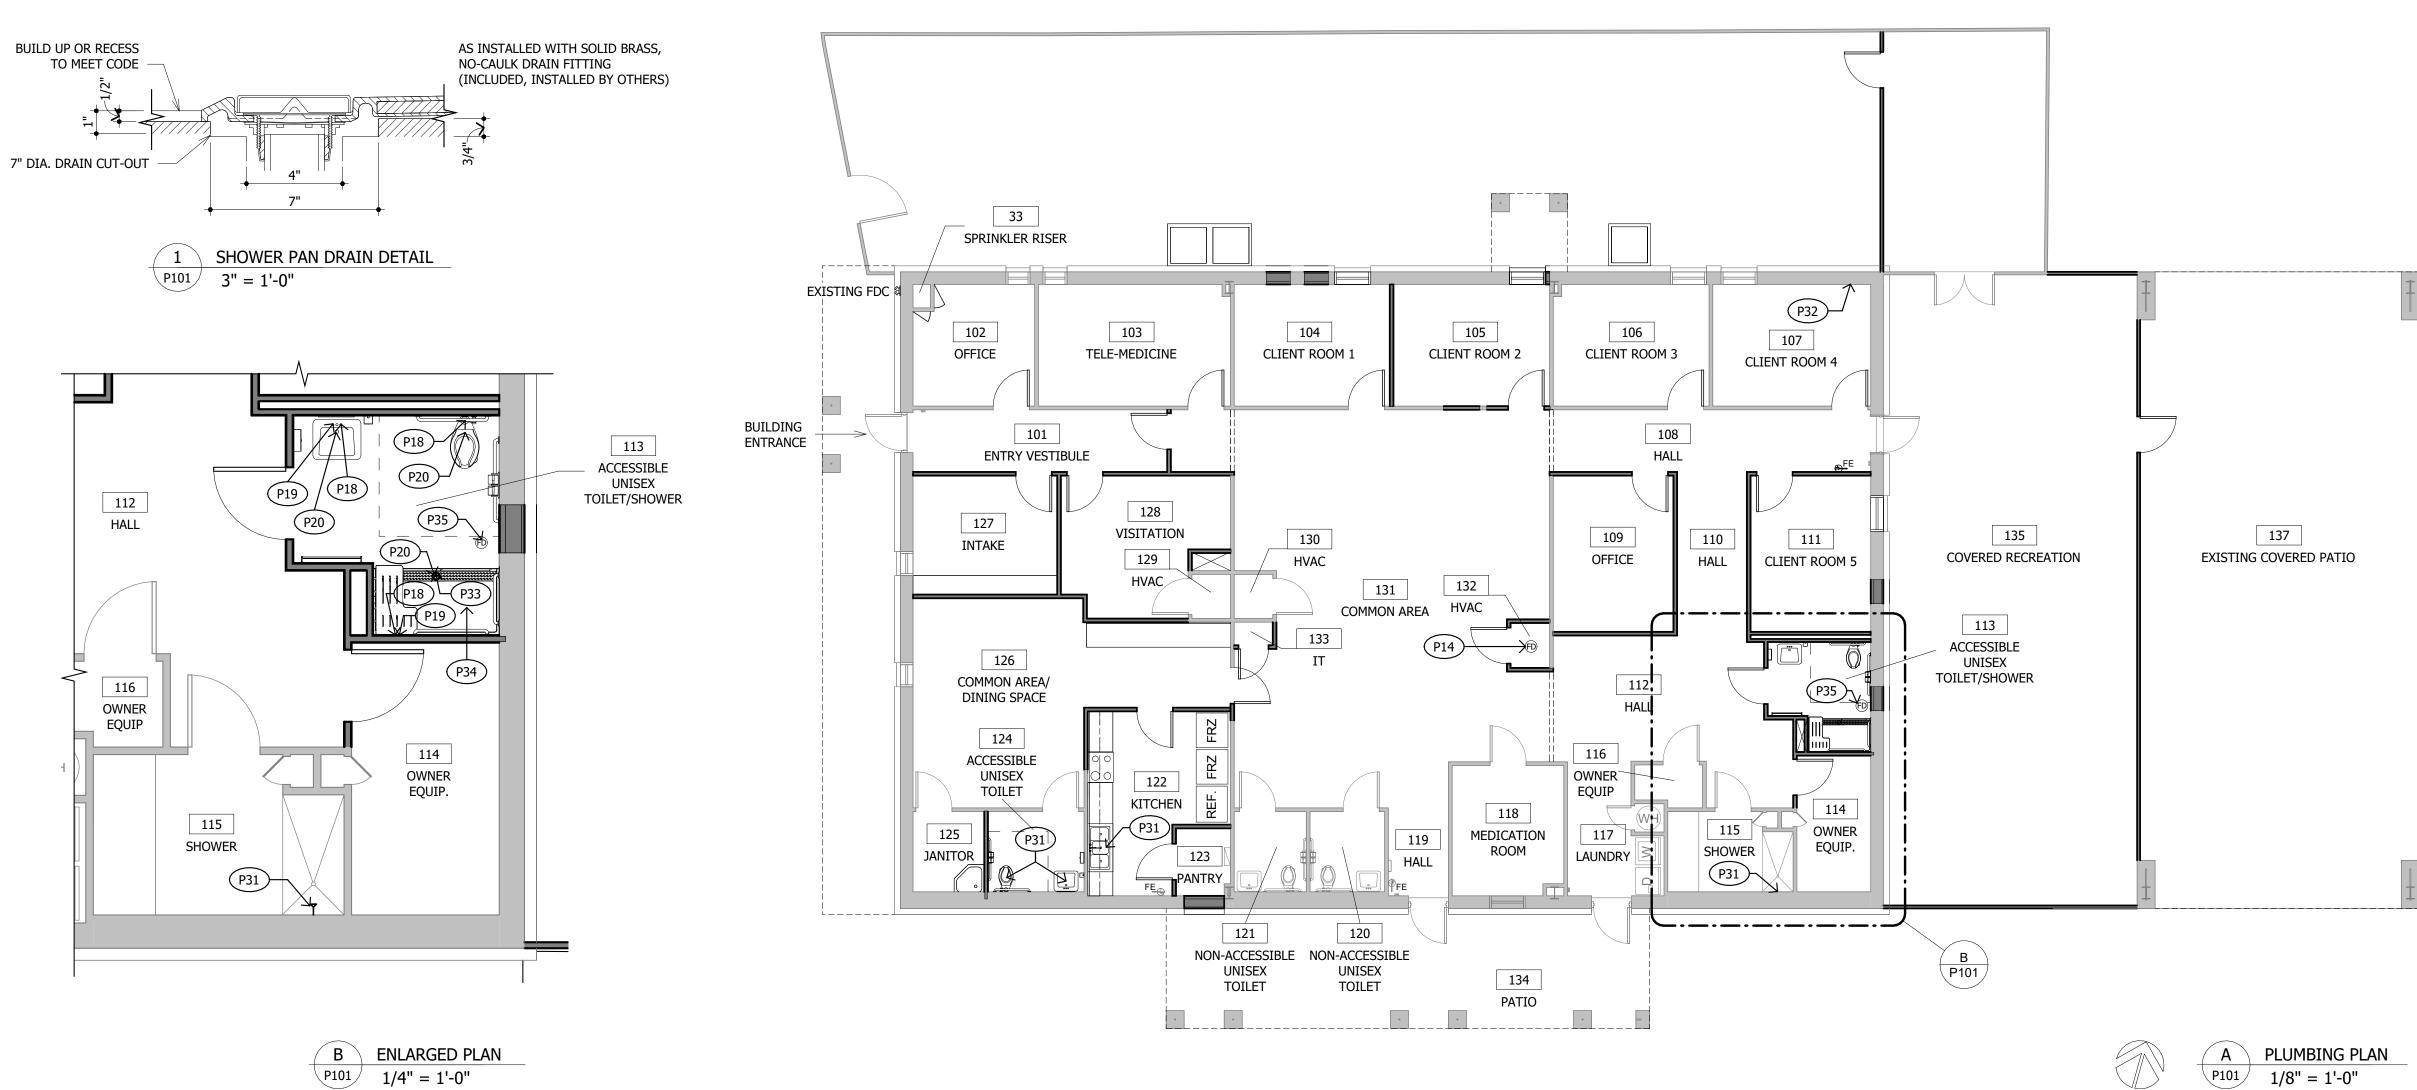
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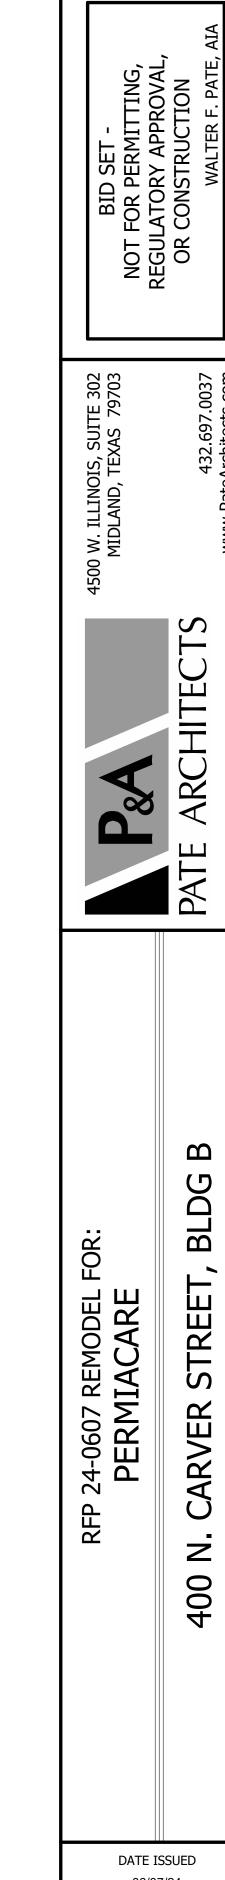
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M101

- ALL PLUMBING TO COMPLY WITH THE INTERNATIONAL PLUMBING CODE, NFPA 90, AND ALL LOCAL, STATE, AND FEDERAL ORDINANCES, CODES, LAWS, AND REGULATIONS.
- PLUMBING SUB VERIFY ALL PIPING SIZES & SUBMIT PIPING DESIGN LAYOUT, FIXTURE & TRIM SUBMITTALS FOR ARCHITECT'S APPROVAL.
- CONTRACTOR VERIFY LOCATION AND SIZE OF EXISTING UTILITY SERVICES.
- POS PROVIDE AND INSTALL PLUMBING VALVES, LINES, FIXTURES, FAUCETS, TRIM, ETC. AS INDICATED AND REQUIRED. MATCH EXISTING.
- P06 CONTRACTOR ENSURE ALL PLUMBING INSTALLATIONS COMPLY WITH LOCAL BACKFLOW REQUIREMENTS. CONTRACTOR PROVIDE AND INSTALL ANY BACKFLOW DEVICES NOT SHOWN ON THESE DRAWINGS AS REQUIRED.
 - PROVIDE PLUMBING FIXTURES SCHEDULED & APPROVED BY ARCHITECT AT LOCATIONS INDICATED.
- WHERE MULTIPLE PLUMBING FIXTURES SHARE A COMMON WALL, PROVIDE BRANCH PIPING TO EACH FIXTURE. PLUMBING SUB PROVIDE PIPING SIZE AS REQUIRED BY PLUMBING FIXTURES & EQUIPMENT.
- P11 EXTEND HW LOOP DOWN IN WALLS AS REQUIRED. PROVIDE HW BRANCHES TO THE FAUCETS WITHIN 24" OF HW LOOP.
- PROVIDE CW, HW, HWR PIPING ABOVE CEILING BUT BELOW INSULATION IN ATTIC SPACE. LOCATE CUT-OFF VALVES FOR EASY FUTURE SERVICE ACCESS, ETC.
- PROVIDE FLOOR DRAIN AND CONDENSATE DRAIN LINES FROM MECHANICAL UNITS INTO FLOOR DRAIN. TIE INTO EXISTING SEWER LINES.
- DOMESTIC COLD WATER. TIE INTO EXISTING WATER LINE.
- DOMESTIC HOT WATER. TIE INTO EXISTING WATER LINE.
- WATER, SANITARY VENT AND SEWER. TIE INTO EXISTING LINES AND VENTS.
- TIE NEW PLUMBING FIXTURE INTO EXISTING LINES.
- EXISTING INSPECTOR TEST PANEL FOR FIRE PROTECTION SPRINKLER SYSTEM.
- PROVIDE DRAIN FOR PRE-FABRICATED SHOWER PAN. SEE DETAIL 1/P101. VERIFY FINAL LOCATION.
- ACCESSIBLE SHOWER PAN BARRIER FREE ARCHITECTURALS INC. MODEL P26333A1FTB.
- PROVIDE FLOOR DRAIN. TIE INTO EXISTING SEWER LINES.





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THE ENTIRE FACILITY TO BE FULLY SPRINKLERED IN FULL COMPLIANCE WITH NFPA 13.

PROPOSED INSTALLER WHO CANNOT SHOW EVIDENCE OF SUCH QUALIFICATIONS.

REGULARLY ENGAGED IN THE INSTALLATION AND DESIGN OF AUTOMATIC SPRINKLER SYSTEMS.

CONTRACTOR TO PROVIDE A "CERTIFICATE OF REGISTRATION" OR PROOF OF QUALIFICATIONS AS REQUIRED BY THE STATE OR THE FIRE MARSHAL. SUBMIT THE FIRE PROTECTION DESIGN AND LAYOUT

MODIFICATIONS TO ARCHITECT AND FIRE MARSHAL FOR APPROVAL. THE ENGINEER MAY REJECT ANY

MODIFICATIONS TO THE EXISTING FIRE PROTECTION SYSTEM TO BE INSTALLED BY AN EXPERIENCED FIRM


NOTE: ELECTRICAL FLOOR PLAN IS SCHEMATIC - LICENSED ELECTRICAL CONTRACTORS TO INSTALL PER ALL GOVERNING CODES.

ELECTRICAL LEGEND

- TYP. TYPICAL
- E EXISTING TO REMAIN "AS IS"
- R RELOCATED
- DUPLEX ELECTRICAL OUTLET WALL MOUNTED (AT 1 '-6" A.F.F. TYP.)
- $\bigoplus_{@xx"}$ DUPLEX ELECTRICAL OUTLET WALL MOUNTED ABOVE COUNTERTOP OR AT HEIGHT INDICATED
- 4-PLEX ELECTRICAL OUTLET WALL MOUNTED (AT 1'-6" A.F.F. TYP.)
- GROUND FAULT INTERRUPTED OUTLET
- DATA OUTLET WALL MOUNTED AT 1'-6" A.F.F. (TYP.) EMPTY BOX WITH CONDUIT STUBBED OUT ABOVE CEILING FOR CABLE SUPPLIED AND INSTALLED BY OWNER. VERIFY HEIGHT
- PHONE OUTLET WALL MOUNTED AT 1'-6" A.F.F. (TYP.) EMPTY BOX WITH CONDUIT STUBBED OUT ABOVE CEILING FOR CABLE SUPPLIED AND INSTALLED BY OWNER. VERIFY OWNER
- LIGHT SWITCH WALL MOUNTED AY 4'-6" A.F.F. (TYP.)
- LIGHT SWITCH WITH DIMMER- WALL MOUNTED AY 4'-6" A.F.F. (TYP.)
- CEILING MOUNTED EXIT LIGHT (MATCH BUILDING STANDARD) WITH EMERGENCY POWER BATTERY
- THERMOSTAT RELOCATE EXISTING AT 4'-6" A.F.F. (TYP.)
- DATA & PHONE LINE AT 1'-6" A.F.F. (TYP.) EMPTY BOX WITH CONDUIT STUBBED OUT ABOVE CEILING FOR CABLED SUPPLIED AND INSTALLED BY OWNER
- VIDEO & OUTLET FOR TV MONITOR AT 1'-6" A.F.F. (TYP.)

ELECTRICAL KEYNOTES

- ALL ELECTRICAL CONSTRUCTION TO COMPLY WITH LOCAL BUILDING CODES AND ORDINANCES.
- CONTRACTOR CALCULATE ELECTRICAL LOADS FOR THE COMPLETED PROJECT. CONTRACTOR VERIFY EXISTING ELECTRICAL SERVICE AVAILABLE AT THE BUILDING. IF ADDITIONAL ELECTRICAL PANELS & BREAKER CAPACITY IS REQUIRED TO ADEQUATELY SERVE THE BUILDING, THEN EXPAND THE CAPACITY BY PROVIDING NEW SUB-PANELS OR REPLACE THE EXISTING ELECTRICAL PANEL. COORDINATE ADDITIONAL CIRCUITS AND/OR PANEL REQUIRED WITH BUILDING OWNER.
- VERIFY ALL EXISTING CONDITIONS (PANEL BOXES, NUMBER OF CIRCUITS IN USE AND AVAILABLE, ETC.).
- DO NOT LOCATE BOXES FOR ELECTRICAL OUTLETS, COMMUNICATION, DATA & PHONE SYSTEM OUTLETS, OR OTHER ELECTRICAL BOXES "BACK TO BACK" IN A WALL. GROUP ELECTRICAL, COMMUNICATIONS (AND OTHER OUTLET BOXES) IN A "GANG" CLOSE TOGETHER.
- IF EXISTING ELECTRICAL OUTLETS, COMMUNICATIONS OUTLETS, OR LIGHT SWITCHES ARE DELETED (AS THE RESULT OF DEMOLITION WORK, THE ADDITION OF A DOOR OPENING, OR SIMILAR WORK) OR IF EXISTING LIGHT FIXTURE SWITCHING IS MODIFIED, THEN TERMINATE THE EXISTING ELECTRICAL CIRCUIT ABOVE THE CEILING OR REWIRE THE DEVICE(S) OR FIXTURE(S) AS REQUIRED.
- E12 EXISTING ELECTRICAL OUTLETS IN WALLS TO REMAIN UNLESS OTHERWISE NOTED.
- E13 VERIFY ELECTRICAL DEVICES HEIGHTS ABOVE FINISHED FLOOR & ABOVE COUNTER TOPS. COMPLY WITH TAS/ADA REQUIREMENTS.
- E14 COORDINATE, NOTIFY AND SCHEDULE ANY POWER INTERRUPTION WITH BUILDING OWNER & OCCUPANTS 48 HOURS (MIN.) IN ADVANCE. E17 PREPARE DOOR FRAMES FOR ELECTRIC STRIKE. CARD READER AND ELECTRIC STRIKE PROVIDED AND INSTALLED BY OWNER.
- E21 WHERE CONFLICT OCCURS IN THE PLANS OR SPECIFICATIONS WITH ANY LOCAL CODES, THE MORE STRINGENT REQUIREMENTS WILL APPLY.

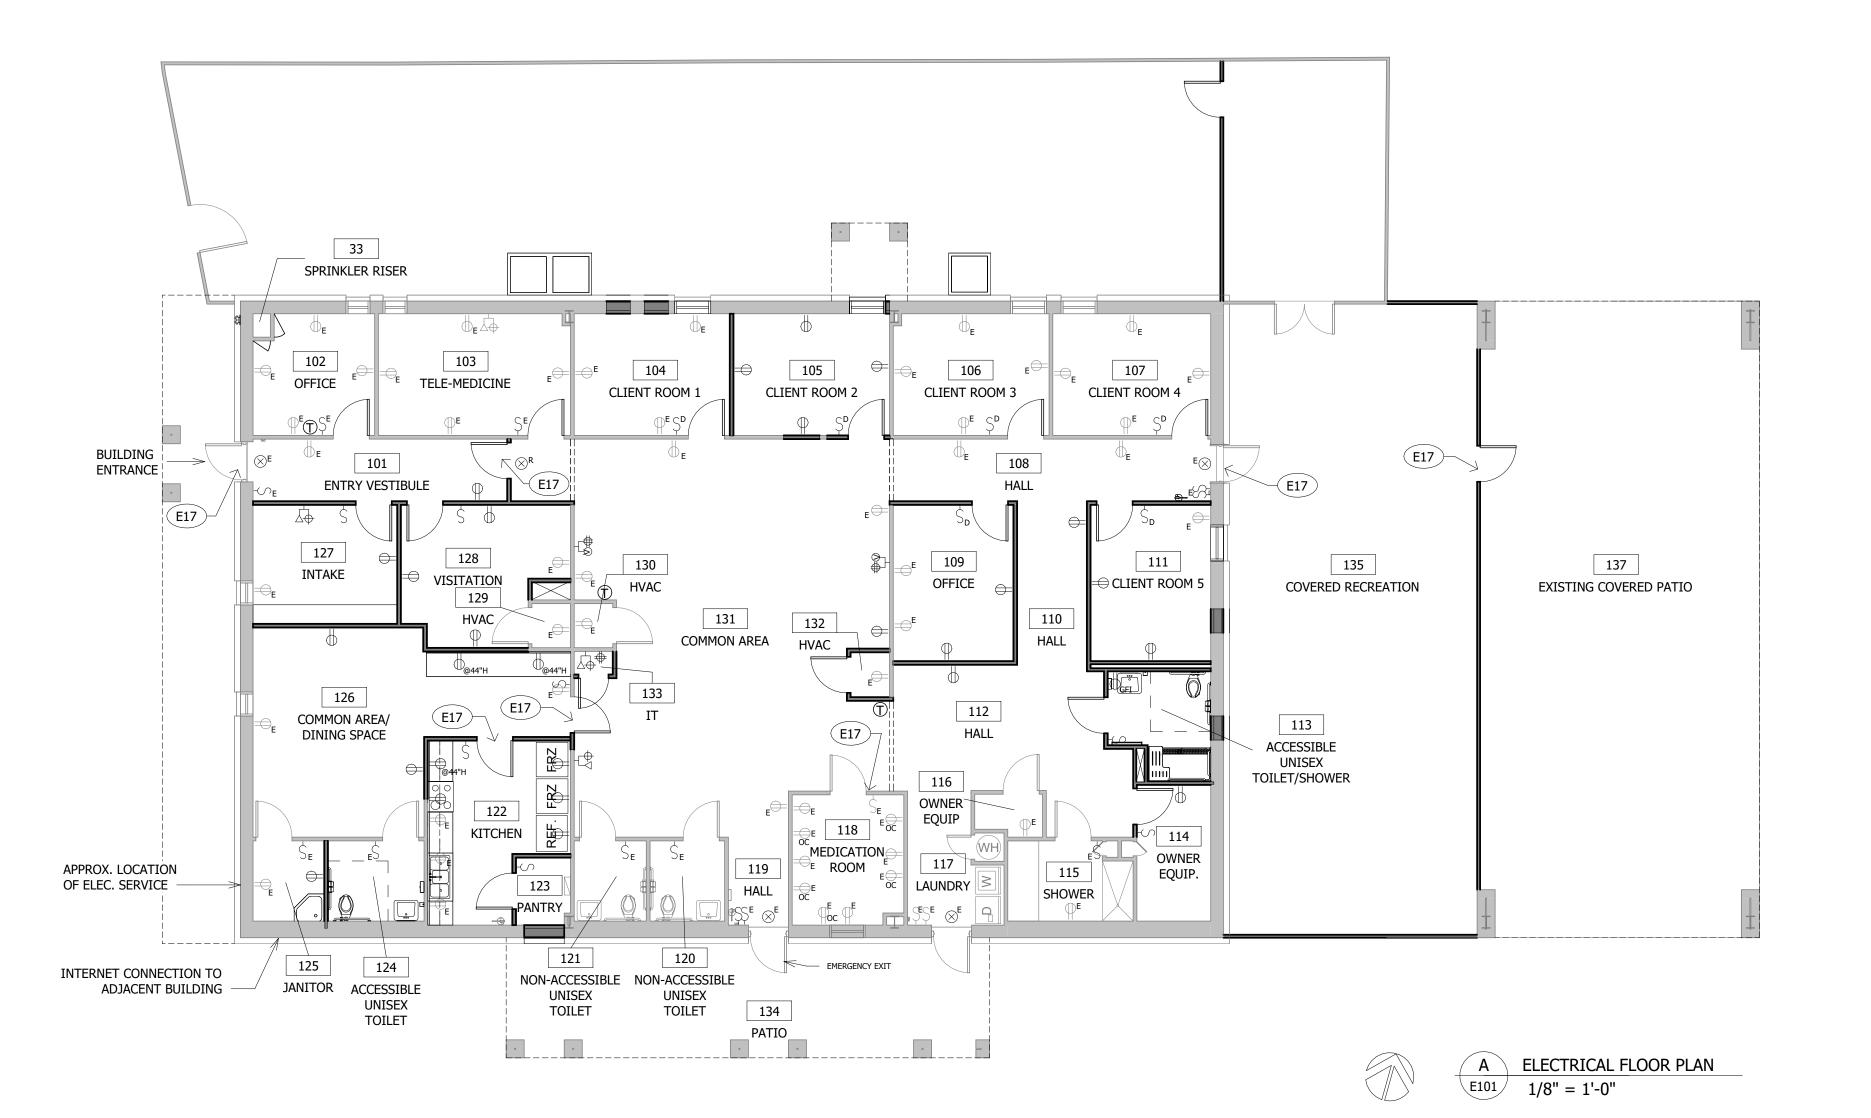

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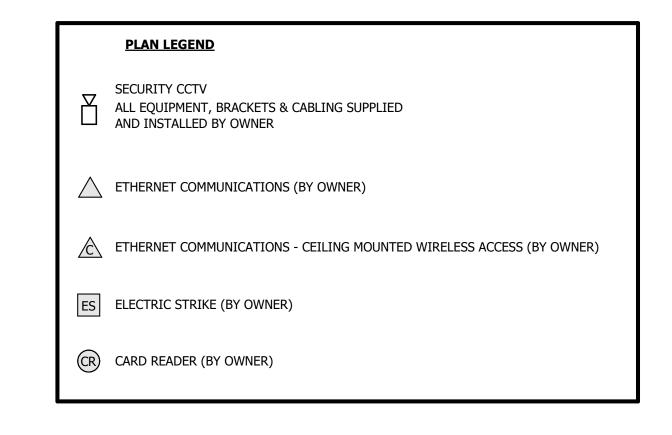
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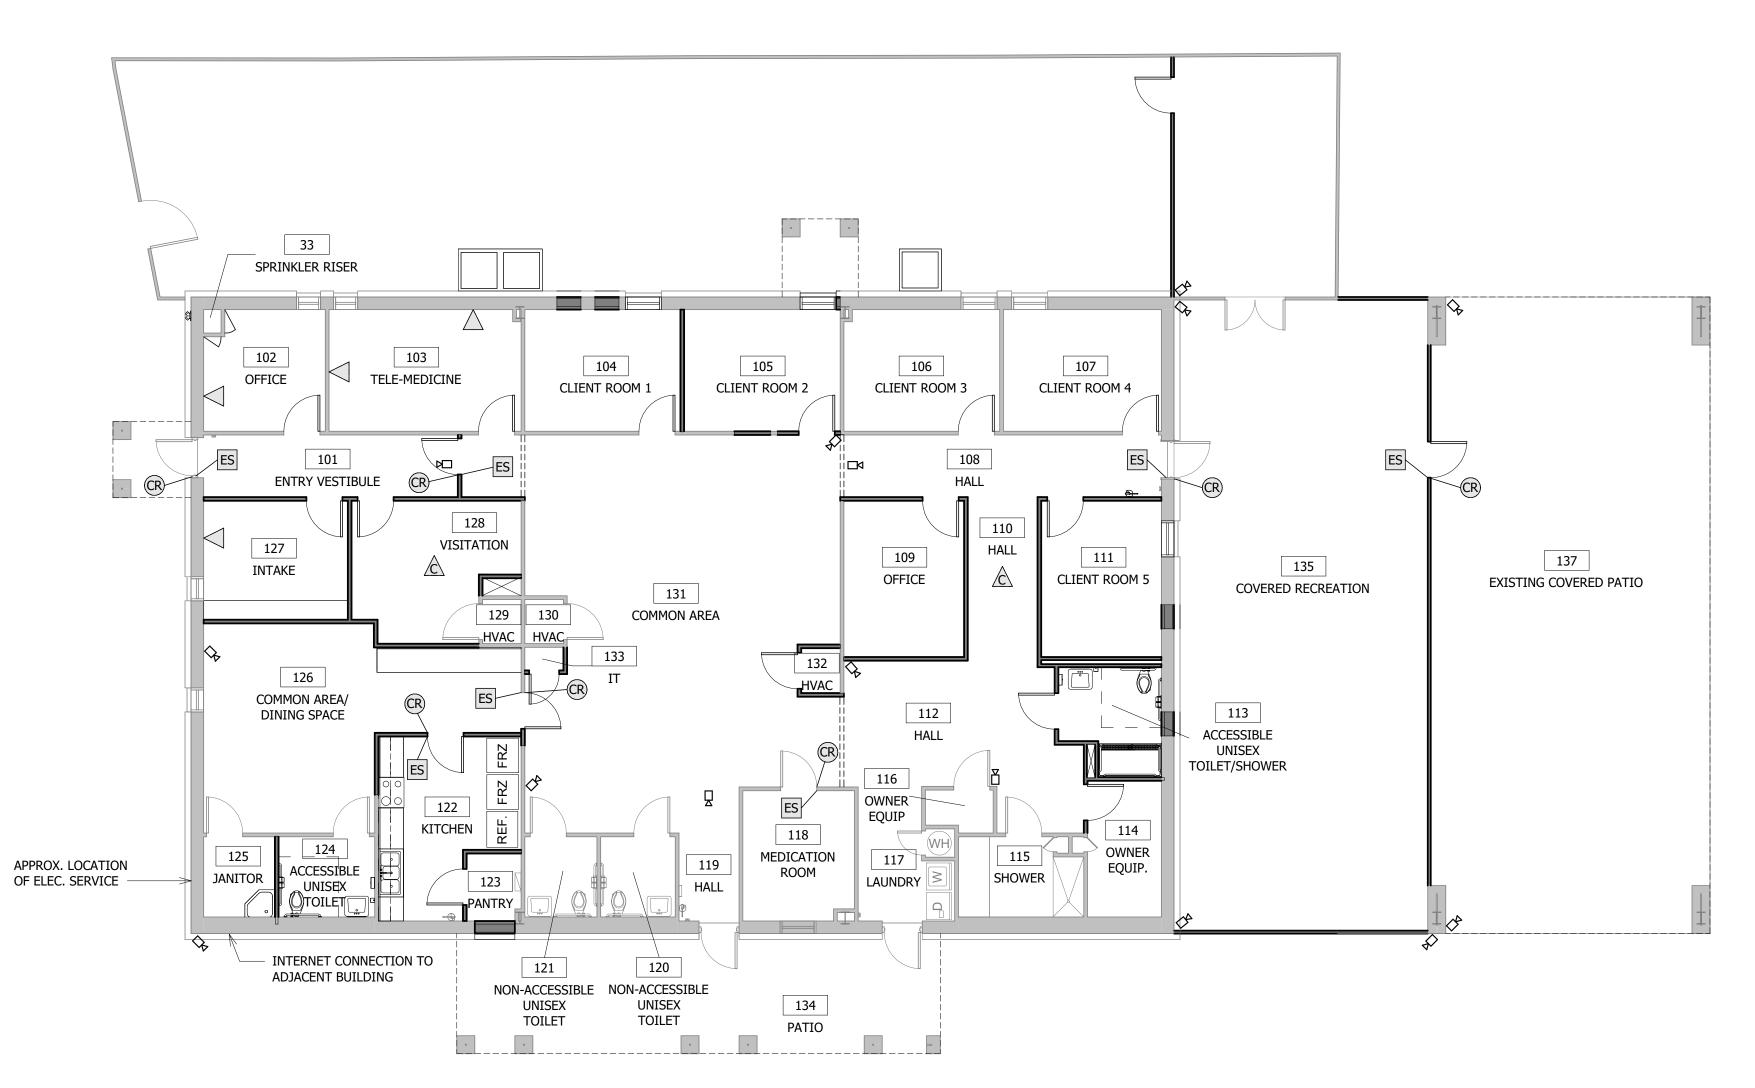
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E101







BLDG STREET, 24-0607 REMODEL F
PERMIACARE CARVER Z

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DATE ISSUED 06/07/24 REVISIONS

E102

SHEET NUMBER

JOB NO.